ARCHITECTURAL NEXUS, Inc



#### SALT LAKE CITY

2505 East Parleys Way Salt Lake City, Utah 84109 **T** 801.924.5000

#### SACRAMENTO

1990 Third Street, Suite 500 Sacramento, California 95811 **T** 916.443.5911

#### Samoan Independent Seventh Day Association of Churches

The current Samoan Independent Seventh Day Association of Churches (SISDAC) is located on the site referenced in this proposal at 1624 South 1000 West, Salt Lake City, UT 84104. Places of worship are accommodated in an RMF-35 Moderate Density Multi-Family Residential District as conditional uses. The purpose of this application is to apply for a conditional use permit to add onto the existing building (Phase 2). The current building was designed as a two-phase project with phase 1 consisting of the current building which includes a post-function/gym space, two classrooms, a small food warming area and building support spaces. The current phase 1 building will remain with slight modifications at the interface between the two phases.

This phase two project consists of the addition of a two-story sanctuary with a second floor added above the existing phase 1 building. The proposed addition will provide a new building entrance and pre-function lobby, a sanctuary, an accessible elevator to the second floor with access to a large classroom, visiting pastor's apartment, offices, and observatory overlooking the sanctuary.

#### **General Operations and Use**

The final phase of the building will hold the same service and operation as the current building with the addition of the visiting pastor apartment. Normal hours of operation are Monday thru Friday, from 9:00 a.m. to 5:00 p.m. There will not be any shift workers in the existing building or its expansion (phase 2), and there will be 3 or 4 employees in the building at any one time. The building will anticipate its peak hours during church services on Saturdays from 9:00 am to 9:00 pm.

The apartment located on the second floor is anticipated to be occupied approximately 4 times a year for about 2-week durations for visiting pastors use. All other times of the year this portion of the building will be unoccupied.

The combined calculated occupancy load of the post function (gymnasium) and sanctuary space is 684 occupants, with a total building occupancy of 740 occupants. There will be select social activities held outside with the use of this building.

The site currently has the maximum number of stalls for the size of the building. When phase 2 is completed, the parking will have some modifications made to the islands to allow for nine additional stalls, which would then meet the minimum stall count required by Salt Lake City's zoning ordinance

21A.44.030. The attached site plan shows circulation and designated parking areas.

Waste generated by the building's use will be stored in large capacity waste containers within the designated trash enclosure on the northwest corner of the site. The waste is removed weekly by a contracted waste management company.

The building is anticipated to consume approximately 1,521 gallons of water per day, and emit 24 tons of CO2 emissions per year. These are averaged estimates since most to the time the building will have minimum occupants requiring less water and energy demand, with large increases during church services.

The site currently has trees with approximately 3-inch or less trunk circumferences. These trees, if effected by the construction of phase 2, will be removed and relocated within the site to accommodate the building addition and parking lot changes. The site will also have minimal grading done since it is relatively flat and has already been prepped for the construction of the addition. It is not anticipated to encounter polluted or contaminated soils that would be removed from the site.

The proposed use will not produce dust, odor, smoke, vibrations, chemicals, toxins, heat, or radiation. The site may produce activity noise during special church occasions (Luau, Easter, Christmas, etc.) and social gatherings such as basketball and volleyball games within the gymnasium.

All utilities are identified and planned for in the attached site plan and civil sheets. The full design of the building was reviewed by the Utility companies prior to the design being reduced to Phase 1 (currently constructed) and phase 2 (addition). Utility company comments have been addressed and planned for the full design that includes this phase of construction.

#### **Adjacent Properties and Uses**

The site to the north is occupied by another church, the Serbian Orthodox Church. The site to the west is occupied by a multi-family residential building. The sites to the south and east (across the street) are occupied by single /two family residential buildings.

All light fixtures used for the project are dark-sky compliant, with full cut-off to stop light distribution at the property boundaries. Some ambient light will be present from building signage, but will be directed to not emit light to the sky or cause glare to neighboring properties.

The site has access to walkways, sidewalks, and public street along 1000 West that feeds to 1700 South. There are no conflicts caused by the proposed addition on the property, nor does it create conflicts to adjacent properties.


All required setback and landscape buffers are being met in accordance with Salt Lake City ordinances. The attached site and landscaping plans illustrate the buffering features utilized for this project.

#### **Zoning Map:**



**Existing Conditions:** Existing Site Aerial Image. Existing building to remain.



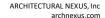



#### SALT LAKE CITY

2505 East Parleys Way Salt Lake City, Utah 84109 **T** 801.924.5000

#### SACRAMENTO

1990 Third Street, Suite 500 Sacramento, California 95811 **T** 916.443.5911

Please see Architectural Nexus' comments below in blue which address how the project, The Samoan Independent Seventh Day Association of Churches (SISDAC) meets each of the required Conditional Use Standards, the City-Wide Master Plan, and the Neighborhood Master Plan of the area where the project is located.

#### 21A.54.080: STANDARDS FOR CONDITIONAL USES:

A conditional use shall be approved if reasonable conditions are proposed, or can be imposed, to mitigate the reasonably anticipated detrimental effects of the proposed sue in accordance with applicable standards set forth in this section. If the reasonably anticipated detrimental effects of a proposed conditional use cannot be substantially mitigated by the proposal of the imposition of reasonable conditions to achieve compliance with applicable standards, the conditional use shall be denied.

- A. **Approval Standards:** A conditional use shall be approved unless the planning commission, or in the case of administrative conditional uses, the planning director or designee, concludes that the following standards cannot be met:
  - 1. The use complies with applicable provisions of this title;

**Architectural Nexus:** Places of worship fall under the conditional use category for the RMF-35 zone in which the proposed building is located. See response to question #3 and provided figures for additional information.

2. The use is compatible, or with conditions of approval can be made compatible, with surrounding uses;

**Architectural Nexus:** The proposed SISDAC addition project will be constructed on an existing church site. The adjacent site to the north also has a church of similar area, height, and foot print. These two churches of different denominations serve the surrounding residents and provide a place for religious gatherings. The neighborhood is accustomed to having a church on the site and it is our intention to continue using the site for the same use.

3. The use is consistent with applicable adopted city planning policies, documents, and master plans;

**Architectural Nexus:** The proposed site (highlighted in the site image below) is in the RMF-35 zone which allows church buildings within the zone as a conditional use. The proposed addition to the existing SISDAC building is a two-story space with a second floor that's max height is under the maximum height limit of 35'.

RMF-35

Moderate Density Multifamily Residential. The purpose of the RMF-35 moderate density multi-family residential district is to provide an environment suitable for a variety of moderate density housing types, including single-family, two-family, and multi-family dwellings with a maximum height of thirty five feet (35').



21A.33.020: TABLE OF PERMITTED AND CONDITIONAL USES FOR RESIDENTIAL DISTRICTS:

Legend: C = Conditional P = Permitted

	Permitted And Conditional Uses By District.																		
Use	FR-1/ 43,56 0	FR-2/ 21,78 0	FR-3/ 12,00 0	R-1/ 12,0 00	R-1 / 7,0 00	R-1 / 5,0 00	SR-	SR- 2	SR-	R-2	RMF - 30	RM F- 35	RMF - 45	RMF - 75	RB	R-MU - 35	R-M U- 45	R-M U	RO
Place of worship on lots less than 4 acres in size	С	С	С	С	С	С	С		С	С	С	С	С	С	С	С	С	С	С

4. The anticipated detrimental effects of a proposed use can be mitigated by the imposition of reasonable conditions;

**Architectural Nexus:** We do not anticipate any detrimental effects linked to the proposed SISDAC expansion project. The project is enhancing the existing place of worship and will have typical hours of operation and use associated with a building of this nature. The project is also adjacent to another church building.

- B. **Detrimental effects determination:** In analyzing the anticipated detrimental effects of a proposed use, the planning commission, or in the case of administrative conditional uses, the planning director or designee, shall determine compliance with each of the following:
  - 1. This title specifically authorizes the use where it is located;

**Architectural Nexus:** The proposed site highlighted in item A.3. above, is in the RMF-35 zone which allows church buildings within the zone as a conditional use. See response to question #3 and provided figures for additional information.

2. The use is consistent with applicable policies set forth in adopted city wide, community and small area master plans and future land use maps.

**Architectural Nexus:** The following summarizes how the SISDAC project meets and supports the SLC City Wide Master Plan.

The addition of the proposed SISDAC project to the community fabric will provide for a diverse mix of uses in the area, which is an underlying principle of the SLC City Wide masterplan. The proposed building will continue the site's legacy of being a place of worship for those in the community. The project supports the stated vision of the master plan in that in introduces and allows for a new religious denomination with an emphasis on a minority community. A quote from the SLC City Wide Master Plan states, "We expect to have true choices about how we live our lives, from what kinds of home we live in, to how we travel to work, shop, worship, or recreate."

The master plan lists several initiatives which we have integrated into the design of the proposed SISDAC project:

Compatibility – We have endeavored to provide the community with a project that will integrate into the surrounding context in terms of scale and character. The proposed building is of a similar foot print and height to the surrounding buildings. The rectilinear forms used integrate into the surrounding context. The material pallet of CMU and painted cement siding are visually compatible with the neighborhood. See question four for additional information and rendering.

**Neighborhoods** – It is our belief that places of worship can help build strong neighborhoods. The project will seek to create stability, provide a conveniently located place of worship, build diversity and encourage social interaction. This project will be the first Seventh Day Association of Churches in the area and the only church focused on the Samoan community.

**Growth** – The SISDAC project will support the mixed-use goal, infill a now otherwise empty lot, and contribute to the healthy lifestyles of those in the community.

**Transportation and Mobility** – As previously stated, SISDAC is the only denomination of its type in the area and the only church focused on the Samoan community. This project will reduce travel out of the community to find a Seventh Day Association of Churches while possibly bringing new people and families into the area. Bringing new people into the area could help support the proposed nearby SLC City Wide Master Plan regional node at 900 west and 1700 south.

**Beautiful City** – Places of worship are naturally people focused. The proposed SISDAC project has been designed to be people oriented. The design is conscious of the surrounding environment and as such the design does not drastically alter the site. Parking and entrances have been kept in the same locations to mitigate disturbances. The building has been pulled back from the road to provide a larger landscaped buffer zone. The building is designed using high building standards, which call for the use of long-lasting materials that are complementary to the surrounding building stock.

**Arts and Culture** – The SISDAC denomination associated with the proposed project will provide a place for the Samoan minority community. The introduction of this proposed project into the community will bring with it opportunities for diversity and the appreciation for new cultures.

**Equity** – As stated previously, the new project will allow the community to welcome a new denomination to the area and provide equal access to a more diverse choice of forms of worship.

3. The use is well suited to the character of the site, and adjacent uses as shown by an analysis of the intensity, size, and scale of the use compared to existing uses in the surrounding area;

Architectural Nexus: The proposed site is adjacent to another church building to the North (Right) and a residence to the south (Left) as shown below. The project is well suited to the character of the site and relative to the intensity, size, and scale of the use compared to the existing surrounding uses. The building steps down in size as it approaches the street in order to create a better transition to the surrounding neighborhood and human scale. See the illustration below which shows the existing building on the site in relation to the surrounding buildings. The addition will extend the foot print to the east no closer than the required front yard setback of 20 feet.



4. The mass, scale, style, design and architectural detailing of the surrounding structures as they relate to the proposed have been considered;

**Architectural Nexus:** The mass and scale have been considered relative to the surrounding building. The materials used on the main taller portion of the building is CMU and brick veneer with the smaller scale portions of the building being painted fiber cement board paneling and fiber cement board. The style design and architectural detailing are intended to create a distinct building identity while still blending in with the surrounding structures.



5. Access points and driveways are designed to minimize grading of natural topography, direct vehicular traffic onto major streets and not impede traffic flows;

**Architectural Nexus:** Existing driveways are utilized for vehicular access to the new project. The parking area for the most part has been maintained in the same location. There should be minimal regrading associated with the new project. Vehicular traffic and parking will remain in the same configuration as the previous church building and parking. The existing driveways and access points will be used and will not impede traffic flow. The driveways will continue to direct traffic onto major streets.

6. The internal circulation system is designed to mitigate adverse impacts on adjacent property from motorized, non-motorized, and pedestrian traffic;

**Architectural Nexus:** The proposed project design has maintained many of the past site element locations such as parking and drive isles. We do not expect to see any adverse impacts regarding parking or pedestrian and vehicular traffic flow.

7. The site is designed to enable access and circulation for pedestrian and bicycles;

**Architectural Nexus:** The SISDAC project facilitates pedestrian and bicycle access with a separate access point protecting them from vehicular obstacles. Bicycle racks have also been provided on site and adjacent to the building.

8. Access to the site does not unreasonably impact the service level of any abutting or adjacent street;

**Architectural Nexus:** The site's layout and use have remained largely unchanged and will not impact the service level of any abutting or adjacent streets.

9. The location and design of off-street parking complies with applicable standards of this code;

**Architectural Nexus:** Off street parking has been provided in accordance with applicable requirements. See the excerpt for sheet AS101 from the provided drawings. See the provided drawings for additional information.

#### PARKING DATA:

REQUIRED PARKING CALCULATIONS  ROOMING HOUSE (1 unit)  PLACES OF WORSHIP (1 stall/300 SF @ 3,174 sf)  ALL OTHER USES (3 stall/1,000 sf @ 6,996)  TOTAL MINIMUM REQUIRED STALLS		1 10 18 <u>29</u>
• REQUIRED ADA STALLS (1 ada / 25 stalls):	2	
PROPOSED PARKING  • EXISTING STALLS (2 ADA)  • NEW STANDARD STALLS  • NEW ADA STALLS  TOTAL PROVIDED PARKING	20 9 0 29	

10. Utility capacity is sufficient to support the use at normal service levels;

**Architectural Nexus:** The uses and size of the building are similar to what it was previously and the utility capacity is sufficient to support the use at normal service levels.

11. The use is appropriately screened, buffered, or separated for adjoining dissimilar uses to mitigate potential use conflicts;

**Architectural Nexus:** The proposed project building respects the required building setbacks. The project also includes a decorative security fencing as well a dumpster enclosure to secure and screen the dumpsters. See the included drawings for additional information.

12. The use meets city sustainability plans, does not significantly impact the quality of surrounding air and water, encroach into a river or stream, or introduce any hazard or environmental damage to any adjacent property, including cigarette smoke;

**Architectural Nexus:** The project will not significantly impact the air, water or encroach into a river or stream. Likewise, the project will not introduce any hazardous environmental damage to any adjacent properties. The project provides value to the community and its residents.

13. The hours of operation and delivery of the use are compatible with surrounding uses;

**Architectural Nexus:** The proposed project will not have hours of operation outside of that which is typical for a place of worship. There will be no shift work associated with the project.

14. Signs and lighting are compatible with, and do not negatively impact surrounding uses; and

**Architectural Nexus:** The lighting and signage are minimal. Most signage is kept to the building and at a reasonable size, with no monument signs. The majority of signage is code related. Lighting is mostly kept to the parking lot and building entrances to provide safety and security for those accessing the site. See the included drawings for additional information.



15. The proposed use does not undermine preservation of historic resources and structures.

**Architectural Nexus:** The proposed building addition does not undermine preservation of historic resources or structures and will be built on an empty site.

- C. **Conditions Imposed:** The planning commission, or in the case of administrative conditional uses, the planning director or the director's designee, may impose on a conditional use any conditions necessary to address the foregoing factors which may include, but are not limited to:
  - 1. Conditions on the scope of the use: its character, location, hours and methods of operation, architecture, signage, construction, landscaping, access, loading and parking, sanitization, drainage and utility, fencing and screening, and setbacks; and
  - 2. Conditions needed to mitigate any natural hazard; assure public safety; address environmental impacts; and mitigate dust, fumes, smoke, odor, noise vibrations; chemicals, toxins, pathogens, gases, heat, light and radiation.
- **D. Denial of Conditional Use:** A proposed conditional use shall be denied if:
  - 1. The proposed use is unlawful; or
  - 2. The reasonably anticipation detrimental effects of the proposed conditional use cannot be substantially mitigated as proposed in the conditional use application or by the imposition of reasonable conditions to achieve compliance with applicable standards set forth in this section.
- E. Notice of Decision: The planning commission, or in the case of administrative conditional use, the planning director or designee, shall provide written notice of the decision, including all conditions imposed to the applicant and local community council within (10) days of the final action. If the conditional use is approved, this notice shall be recorded against the property by the city recorder. (Ord. 14-12, 2012)

#### SITE PLAN REQUIREMENTS

#### REQUIRED CONTENT

The required site plan shall consist of all the details of the proposed development submitted for review by this department.

All plans shall be accurately drawn to scale of not less than 1" (inch) equals 20' (feet) and contained on a sheet size not less than 8.5" X 11". All proposals must clearly illustrate the following BASIC SITE PLAN features 1 - 6 and only larger projects must include MAJOR SITE PLAN features 1 - 10.

Building Services & Code Enforcement // slc.gov/buildingservices // 801.535.6000

#### BASIC SITE PLAN = (REFER TO)


- Verified property line location, dimensions, direction from back of the curb or sidewalk to property line, dimension of parkway strip, lot square footage, scale and north arrow direction. (AS101)
- Streets, alley, affected easements, and right-ofways. (NONE)
- Location and dimensions of all hard surfaced areas including curb and gutter, sidewalks, driveways, parking spaces, loading areas, garbage areas, and access points to public streets or alleys (CP501, AS101 & AS701)
- 4. The size, shape, and location of all existing and proposed structures including overhang projections, garages, carports, sheds, and the distance to the nearest point of any dwelling on abutting properties. 10' required from garage to nearest dwelling on adjacent lot(s). (AS101)
- Front, side, and rear yard setback dimensions from property line to all existing and proposed structures. (AS101)
- Parking strip layout, including lawn areas, location of existing and proposed street trees, sprinkler system, and curb cuts. (AS101, LI101, LI601, LP101, & LP601)

#### MAJOR SITE PLAN = (REFER TO)

- The size, shape, and location of all existing landscape features including large trees, pools, decks, patios, exterior lighting, utility lines, steams, and any other exterior element. (CS101, CU101, AS101, AS701, AS702, LI101, LI601, LP101, LP601)
- Landscape plan including location, spacing, size, quantity, and type of all proposed plant materials and installation details. (LP101, LP601, & LP701)
- Sprinkler plan including location, spacing, and size of all shrub or lawn heads, water lines, and valves. (LI101, LI601, LI701 & LI702)
- Location and height of fences, retaining walls, and railings. (CP101, AS101 & AS702)
- Contour lines indicating existing and proposed grade changes at intervals not to exceed 2'. (CS101 & CG101)
- Location, height, size, and design of all existing and proposed exterior signs and advertising features. (A201)
- Location and type of catch basins or surface water detention basins and other surface drainage facilities. (CG101)
- 8. Show all existing and proposed public way improvements. (AS101)
- Show the location, setbacks and dimensions of all existing and proposed ground mounted utility boxes on private property and in the public right-of-way. (CU101)
- Showthe location, setbacks and dimensions of all existing and proposed air conditioning units. (A121)





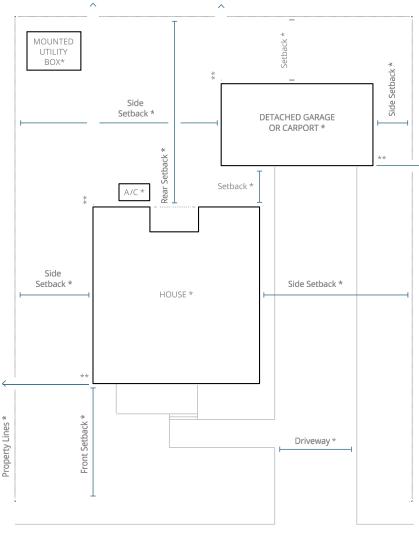

Sidewalk	Approach
Parking Strip	Width*
Street	

SAMOAN INDEPENDENT

# ARCH | NEXUS

SEVENTH-DAY ADVENTIST CHURCH

Architectural NEXUS, Inc. 2505 East Parleys Way Salt Lake City, UT 84109 T 801.924.5000

Architect retains total ownership and control. The design represented by these drawings is sold to the client for a one time use, unless otherwise agreed upon in writing by the Architect.

# SISDAC Utah, Phase 2

1624 S 1000 W SALT LAKE CITY, UT 84104

Nexus Project #: 21021.01

Owner Project #:

Signer 4

31 JULY 2024

#### CONDITIONAL USE PERMITTING

#### **APPROVALS**

Signer 1	Date
Signer 2	Date

Signer 3 Date

# Date Revision

SAMOAN INDE

Date





NEXUS PROJECT #21021.01 CHECKED BY: -DRAWN BY: -DATE: 31 JULY 2024

COVER SHEET



#### OWNER

#### Samoan Independent Seventh-Day Adventist Church

Salt Lake City, UT 84104
E-MAIL: mpatu.secretaryutah@gmail.com

CONTACT: Marilyn Spizzirri-Patu E-MAIL: mpatu PHONE: 385.775.0313 INTERNET:

CONTACT: Aaron Arbuckle PHONE: 801.924.5000

CONTACT: Greg Nelson

PHONE: 801.359.5565

CONTACT: Josh Blazzard

PHONE: 801.782.6008

CONTACT: Ben Davis

PHONE: 801.530.3148

**ENGINEERS** 

EELD

#### ARCHITECT

Architectural NEXUS, Inc. 2505 East Parleys Way

2505 East Parleys Way
Salt Lake City, UT 84109

MAIL: aarbuckle@archnexus.com

INTERNET: http://www.archnexus.com

CRS 4246 S Riverboat Rd, Ste 200 Salt Lake City, UT 84123

E-MAILgregory.nelson@crsengineers.com

STRUCTURAL ARW Engineers 1594 Park Circle

Ogden, Utah 84404

E-MAIL: JoshB@arwengineers.com

INTERNET:

MECHANICAL VBFA

330 South 300 East Salt Lake City, UT 84111

E-MAIL: bdavis@vbfa.com

ELECTRICAL EELD

1220 S 300 W Salt Lake City, UT 84101

CONTACT: Mansour Aghdasi E-MAIL: mansour@ee-ld.com
PHONE: 801.486.2222 INTERNET:

A

G-001

**GENERAL** INFORMATION & SHEET **INDEX** 

#### PHASE 2 SHEET INDEX

GENERAL:	
G-001	COVER SHEET
G-002	GENERAL INFORMATION & SHEET INDEX
G-003	GENERAL INFORMATION
G-701	ACCESSIBILITY COMPLIANCE
4	
CIVIL:	
C-001	TITLE SHEET
C-002	GENERAL NOTES & ABBREVIATIONS
CD101	DEMOLITION PLAN
CS101	EXISTING CONDITIONS
CG101	GRADING PLAN
CP101	SITE PLAN
CP501	SITE & UTLITY DETAILS
CU101	UTILITY PLAN
CU501	UTILITY DETAILS
9	
LANDSCAP	E:
LI101	IRRIGATION PLAN
LI601	IRRIGATION LEGEND
LI701	IRRIGATION DETAILS
LI702	IRRIGATION DETAILS
LP101	PLANTING PLAN
LP601	PLANTING LEGEND
LP701	LANDSCAPE DETAILS

ARCHITECTURAL: SITE IMPROVEMENT PLAN AREA CALCULATIONS SITE IMPROVEMENT DETAILS PHASE 2 - LEVEL 01 FLOOR PLAN PHASE 2 - LEVEL 02 FLOOR PLAN PHASE 2 - ROOF PLAN PHASE 2 - BUILDING ELEVATIONS PHASE 2 - BUILDING SECTIONS

TOTAL SHEETS IN PHASE 2: 29

TYPICAL DETAILS

#### **LOCATION**



#### **DESIGN CRITERIA**

APPLICABLE CODES		OTHER CRITERIA			
ACCESSIBILITY CODE	ICC/ANSI A117.1-2009	INTERNATIONAL FUEL GAS CODE	2021 EDITIO		
INTERNATIONAL BUILDING CODE	2021 EDITION				
INTERNATIONAL ENERGY CONSERVATION CODE	2021 EDITION				
INTERNATIONAL FIRE CODE	2021 EDITION				
INTERNATIONAL MECHANICAL CODE	2021 EDITION				
INTERNATIONAL PLUMBING CODE	2021 EDITION				
NATIONAL ELECTRICAL CODE	2020 EDITION				
ZONING ORDINANCE: SALT LAKE CITY	ZONING CODE TITLE 21A				

#### DEFERRED SUBMITTALS

DEFERRED SUBMITTAL LIST TO INCLUDE:

- AUTOMATIC FIRE SPRINKLER SYSTEMS
- FIRE ALARM SYSTEMS
- PRE-MANUFACTURED WOOD AND STEEL STRUCTURAL ELEMENTS
- RAMMED AGGREGATE PIERS
- 1. DEFERRED SUBMITTAL ITEMS MUST BE REVIEWED AND APPROVED BY THE DESIGN PROFESSIONAL OF RECORD AND RECEIVED BY SALT LAKE CITY WITHIN 60 DAYS OR AGREED UPON TIMELINE OF PERMIT ISSUANCE.
- 2. NO DEFERRED EQUIPMENT CAN BE INSTALLED PRIOR TO APPROVAL BY SALT LAKE CITY.
- 3. A STOP WORK ORDER CAN BE ISSUED BY THE INSPECTOR IF WORK PROGRESSES BEYOND WHAT HAS BEEN APPROVED.
- 5. THE FINAL INSPECTION APPROVAL CANNOT BE ISSUED, AND NO BUILDING OR STRUCTURE CAN BE USED OR OCCUPIED UNTIL ALL THE DEFERRED SUBMITTAL ITEMS ARE APPROVED BY THE BUILDING AND FIRE OFFICIALS.

GLASS-FIBER-REINFORCED

GYPSUM WALL BOARD

GLASS-FIBER-REINFORCED GYPSUM

INSIDE DIAMETER: INSIDE DIMENSION

RISER OR RADIUS

REFLECTED CEILING PLAN

**RADIUS** 

**ROOF DRAIN** 

REQUIRED

REVISION

ROOM

REFRIGERATOR

**RELATIVE HUMIDITY** 

RAIN WATER LEADER

SMOKE DETECTOR

SCHEDULE

**SPECIFICATION** 

STAINLESS STEEL

SECTION

STANDARD

TREAD

THICK

TELEPHONE

**TEMPORARY** 

TOP OF CONCRETE

TOP OF MASONRY

TOP OF PARAPET

TOP OF WALL

**TYPICAL** 

TOP OF

**VERTICAL** 

VESTIBULE

WITH

**WITHOUT** 

WOOD

**VERIFY IN FIELD** 

WALL HYDRANT

WORKING POINT

THE PRECEDING LIST OF ABBREVIATIONS

IS PRESENTED AS A GENERAL GUIDE AND

GENERALLY ACCEPTED ABBREVIATIONS

MAY BE FOUND AMONG THE DRAWINGS

SOME ABBREVIATIONS SHOWN ABOVE

MAY NOT BE USED WITHIN THIS DRAWING

DOES NOT NECESSARILY SHOW ALL

ABBREVIATIONS USED. OTHER

(NOT USED)

WEATHER RESISTIVE BARRIER

TOP OF SLAB; TOP OF STEEL

UNDERWRITER'S LABORATORIES

UNLESS NOTED OTHERWISE

VINYL COMPOSITE TILE

STRUCT STRUCTURAL

SIMILAR

SELF ADHESIVE MEMBRANE

**ROUGH OPENING** 

**ROOF TOP UNIT** 

RAD

RCP

RD

REF

REQD

**REV** 

RM

RO

RTU

SAM

SECT

SPEC

SIM

SS

STD

TEL

THK

TOC

TOM

TOP

TOS

TOW

TYP

TO

**VERT** 

VEST

VIF

W/O

WD

WH

WP

WRB

TEMP

SCHED

GAUGE

**GLASS** 

GYPSUM

HIGH

HOSE BIBB

**HIGH POINT** 

HOUR

INCH

INFORMATION

INTERIOR

**JANITOR** 

(NOT USED)

LABORATORY

LONG LEG HORIZONTAL

LONG LEG VERTICAL

LAVATORY

LOW POINT

MACH RM MACHINE ROOM

MAXIMUM

MANUFACTURER

MASONRY OPENING

**NOT APPLICABLE** 

NOT TO SCALE

ON CENTER

NOT IN CONTRACT

OUTSIDE DIAMETER

OUTSIDE DIMENSION

OVERFLOW DRAIN

OVERHEAD DOOR

OPPOSITE HAND

PLASTIC LAMINATE

POUNDS PER SQUARE INCH

POUNDS PER SQUARE FOOT

POLYVINYL CHLORIDE

**QUARRY TILE** 

OPPOSITE

ORIGINAL

PLASTER

PAIR

PLUMB PLUMBING

MECHANICAL

MEZZANINE

MINIMUM

NOMINAL

**POUNDS** 

HEIGHT

**HOLLOW METAL** 

HEADER

GALV

GL

**GWB** 

GYP

HDR

HPT

HR

LAV

LBS

LLV

LPT

MFR

MO

NOM

NTS

OC

OD

OPP

PLAS

PR

PSF

PVC

GALVANIZED

CONCRETE

AIR CONDITIONING

AIR HANDLING UNIT

ABOVE FINISHED CEILING

ABOVE FINISHED FLOOR

AREA DRAIN

ALUMINUM

ANODIZED

ARCHITECT

**BOARD** 

BUILDING

**CELSIUS** 

COAT HOOK

CORNER GUARD

**CONTROL JOINT** 

CENTERLINE

CLOSET

CLEAR

COLUMN

CONCRETE

CONTINUOUS

CORRIDOR

DEEP DEGREE

DEMOLITION

**DIAMETER** 

DIMENSION

DOWNSPOUT

**EXPANSION JOINT** 

EXTERIOR INSULATION AND FINISH

DRAWINGS

ELEVATION

ELECTRICAL

**ELEVATOR** 

**EQUIPMENT** 

**EXISTING** 

EXPOSED

EXTERIOR

FAHRENHEIT

FIRE ALARM

FLOOR DRAIN

FINISH GRADE

FOUNDATION

FINISH **FLOOR** 

EQUAL

EDGE OF SLAB

EXISTING ROOF DRAIN

ELECTRIC WATER COOLER

FIRE ALARM CONTROL PANEL

FIRE EXTINGUISHER CABINET

FIRE EXTINGUISHER

FIRE HOSE CABINET

FINISHED OPENING

FACE OF MASONRY

FACE OF STUD FACE OF WALL

FIRE STANDPIPE

FIELD VERIFY

FEET

FACE OF CONCRETE

FIBER REINFORCED GYPSUM

FIRE DEPARTMENT CONNECTION

DOWN

EACH

**CERAMIC TILE** 

**CONSTRUCTION JOINT** 

CABINET UNIT HEATER

DRINKING FOUNTAIN

CONTRACTOR FURNISHED,

**CONTRACTOR INSTALLED** 

CONTINUOUS INSULATION

CONCRETE MASONRY UNIT

**BOTTOM OF** 

ANOD

ARCH

CL

CLG

CLO

CLR

CMU

COL

CONC

CONT

CORR

CTJ

DEG

DF

DIM

DN

DS

EJ

ELEC

**ELEV** 

EOS

ERD

EQUIP

EWC

**EXIST** 

EXP

FHC

FIN

FND

FOC

FOM

FOS


FOW

FSP

FT

F۷

**DWGS** 

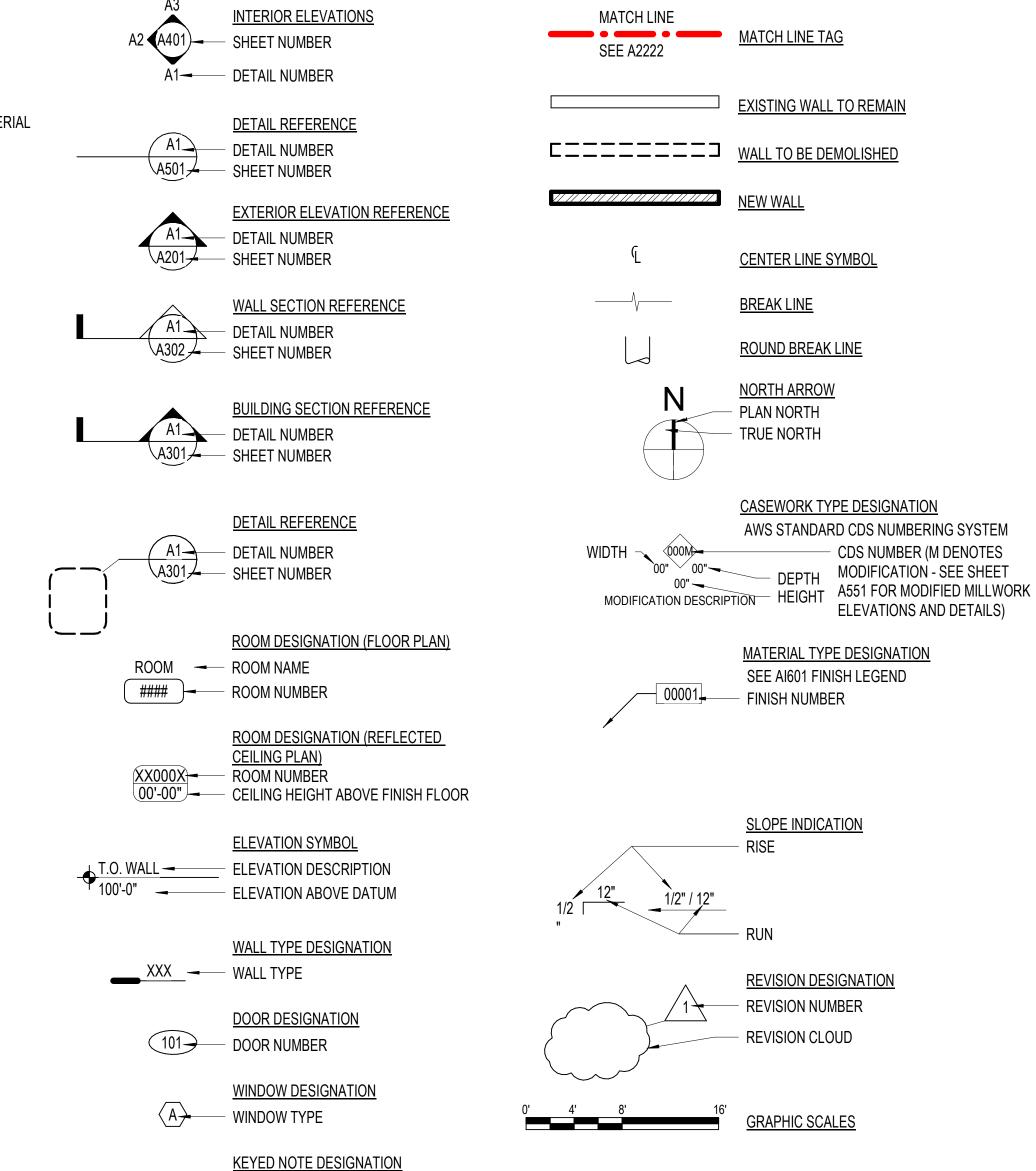

**KEY NOTE NUMBER** 

00001 — EQUIPMENT NUMBER

— GLASS TYPE

**EQUIPMENT DESIGNATION** 

**GLASS TYPE DESIGNATION** 

ARCH NEXUS

Architectural NEXUS, Inc. 2505 East Parleys Way Salt Lake City, UT 84109 T 801.924.5000

http://www.archnexus.com

Original drawings remain the property of the Architect and as such the Architect retains total ownership and control. The design represented by these drawings is sold to the client for a one time use, unless otherwise agreed upon in writing by the Architect. © Architectural Nexus, Inc. 2017

AY CH

PENDE!

SAMOAN

# Date

Revision

CONDITIONAL USE **PERMITTING** 

NEXUS PROJECT #21021.01 CHECKED BY: DRAWN BY: DATE: 31 JULY 2024

**GENERAL INFORMATION** 

#### **GENERAL NOTE - ACCESSIBILITY**

A. THESE DETAILS ARE SHOWN FOR MINIMUM ACCESSIBILITY REQUIREMENTS. SEE PROJECT SPECIFIC DETAILS FOR ADDITIONAL INFORMATION. VERIFY WITH ARCHITECT ANY DIFFERENCES BEFORE PROCEEDING WITH



Architectural NEXUS, Inc. 2505 East Parleys Way Salt Lake City, UT 84109 T 801.924.5000

http://www.archnexus.com Original drawings remain the property of the Architect and as such the Architect retains total ownership and

control. The design represented by these drawings is sold to the client for a one time use, unless otherwise agreed upon in writing by the Architect. © Architectural Nexus, Inc. 2017

SAMOAN INDEPENDENT SEVENTH-D. ADVENTIST CHUR

Date

Revision

CONDITIONAL **USE PERMITTING** 

NEXUS PROJECT #21021.01 CHECKED BY: DRAWN BY: DATE: 31 JULY 2024

**ACCESSIBILITY** COMPLIANCE

G-701

## SISDAC UTAH ARCH NEXUS-SAMOAN CHURCH 100% DESIGN

**STATE OF UTAH** 

PROJECT LOCATION

1624 S 1000 W SALT LAKE CITY, UTAH

**ISSUE DATE:** 

JULY 2024

**LEGEND** 


COUNTY LINE



SHEET LIST TABLE

	···—— · ·	
SHEET NUMBER	SHEET TITLE	SHEET DESCRIPTION
1	C-001	TITLE SHEET
2	C-002	GENERAL NOTES AND ABBREVIATION
3	CS101	EXISTING CONDITIONS
4	CD101	DEMOLITION PLAN
5	CP101	SITE PLAN
6	CG101	GRADING PLAN
7	CU101	UTILITY PLAN
8	CP501	SITE & UTILITY DETAILS

**VICINITY MAP** 

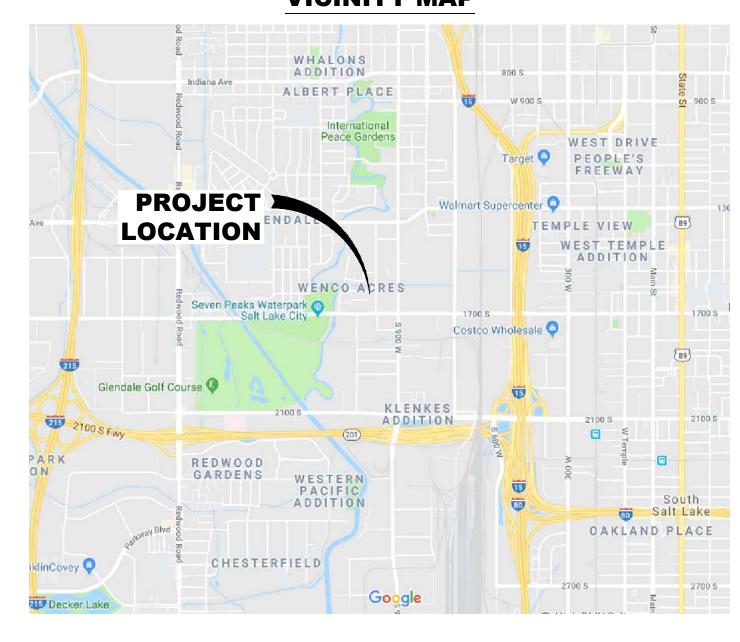



ARCH NEXUS-SAMOAN CHURCH

PROJECT VICINITY MAP

IF THE ABOVE SCALE BAR DOES NOT MEASURE 1-INCH IN LENGTH, DO NOT USE THIS DRAWING FOR SCALING G. NELSON, PE PURPOSES. DIMENSIONS AND MEASUREMENTS SPECIFIED IN THE DRAWING TAKE PRECEDENCE TO SCALED MEASUREMENTS. G. NELSON, PE O. SORENSON, PE THE INFORMATION CONTAINED IN THIS DRAWING IS THE PROPERTY OF CRS ENGINEERS AND IS NOT TO BE REPRODUCED, MODIFIED OR USED FOR ANY OTHER PROJECT OR EXTENSION OF THIS PROJECT EXCEPT BY AGREEMENT WITH CRS ENGINEERS. JULY 2024



SISDAC UTAH
ARCH NEXUS-SAMOAN CHURCH TITLE SHEET

18065C C-001

1624 S 1000 W

SALT LAKE CITY, UTAH

#### GENERAL NOTES:

- ALL IMPROVEMENTS SHALL BE CONSTRUCTED IN STRICT ACCORDANCE WITH ALL JURISDICTIONAL AUTHORITIES.
- 2) CONTRACTOR SHALL COMPLY WITH THE STANDARDS INDICATED ABOVE AND WITHIN THE CONSTRUCTION DOCUMENTS. THE CONTRACTOR SHALL NOTIFY ALL AGENCIES, OWNERS, ENGINEERS, AND UTILITY COMPANIES 5 DAYS PRIOR TO A PRE-CONSTRUCTION MEETING:

OWNER:

SISDAC UTAH 1624 S 1000 W SALT LAKE CITY, UTAH 84104 PHONE: (385) 259-6466 CONTACT: XXXXX

**ENGINEER:** 

CRS ENGINEERS 4246 S RIVERBOAT ROAD SALT LAKE CITY, UTAH 84123 PHONE: (801) 359-5565 FAX: (801) 359-4272 CONTACT: G. NELSON

- 3) IT IS INTENDED THAT THESE PLANS AND SPECIFICATIONS REQUIRE ALL LABOR AND MATERIALS NECESSARY AND PROPER FOR THE WORK CONTEMPLATED AND THAT THE WORK BE COMPLETED IN ACCORDANCE WITH THEIR TRUE INTENT AND PURPOSE. THE CONTRACTOR SHALL NOTIFY THE ENGINEER IMMEDIATELY REGARDING ANY DISCREPANCIES OR AMBIGUITIES WHICH MAY EXIST IN THE PLANS OR SPECIFICATIONS THE ENGINEER'S INTERPRETATION THEREOF SHALL BE CONCLUSIVE.
- 4) WHERE THE PLANS OR SPECIFICATIONS DESCRIBE PORTIONS OF THE WORK IN GENERAL TERMS BUT NOT IN COMPLETE DETAIL, IT IS UNDERSTOOD THAT ONLY THE BEST GENERAL PRACTICE IS TO PREVAIL AND THAT ONLY MATERIALS AND WORKMANSHIP OF THE FIRST QUALITY
- 5) THE CONTRACTOR SHALL BE SKILLED AND REGULARLY ENGAGED IN THE GENERAL CLASS AND TYPE OF WORK CALLED FOR IN THE PROJECT PLANS AND SPECIFICATIONS. THEREFORE, THE OWNER IS RELYING UPON THE EXPERIENCE AND EXPERTISE OF THE CONTRACTOR, IT SHALL BE EXPECTED THAT PRICES PROVIDED WITHIN THE CONTRACT DOCUMENTS SHALL INCLUDE ALL LABOR AND MATERIALS NECESSARY AND PROPER FOR THE WORK CONTEMPLATED AND THAT THE WORK BE COMPLETED IN ACCORDANCE WITH THEIR TRUE INTENT AND PURPOSE
- THE CONTRACTOR SHALL BE COMPETENT, KNOWLEDGEABLE, AND HAVE SPECIAL SKILLS ON THE NATURE, EXTENT, AND INHERENT CONDITIONS OF THE WORK TO BE PERFORMED. CONTRACTOR SHALL ALSO ACKNOWLEDGE THAT THERE ARE CERTAIN PECULIAR AND INHERENT CONDITIONS EXISTENT IN CONSTRUCTION OF PARTICULAR FACILITIES, WHICH MAY CREATE, DURING THE CONSTRUCTION PROGRAM, UNUSUAL OR PECULIAR SAFETY CONDITIONS, WHICH CONDITIONS COULD BE HAZARDOUS TO PERSONS, PROPERTY AND THE ENVIRONMENT. CONTRACTOR SHALL BE AWARE OF SUCH PECULIAR RISKS AND HAVE THE SKILL AND EXPERIENCE TO FORESEE AND TO ADOPT PROTECTIVE MEASURES TO ADEQUATELY AND SAFELY PERFORM THE CONSTRUCTION WORK WITH RESPECT TO SUCH HAZARDS.
- THE CONTRACTOR SHALL BE RESPONSIBLE FOR ALL PERMITS AND LICENSES REQUIRED FOR THE CONSTRUCTION AND COMPLETION OF THE PROJECT, AND SHALL PERFORM ALL WORK IN ACCORDANCE WITH THE REQUIREMENTS AND CONDITIONS OF ALL PERMITS AND APPROVALS APPLICABLE TO THIS PROJECT. THE CONTRACTOR SHALL ENSURE THAT THE NECESSARY RIGHTS-OF-WAY, EASEMENTS, AND/OR PERMITS ARE SECURED PRIOR TO CONSTRUCTION.
- 8) CONTRACTOR SHALL OBTAIN AN ENCROACHMENT PERMIT WHERE APPLICABLE FOR ANY WORK DONE WITHIN RIGHTS-OF-WAY OR EASEMENTS FROM SALT LAKE CITY, UTAH AND UDOT. CONTRACTOR SHALL NOTIFY CITY, COUNTY, AND/OR STATE, 24 HOURS IN ADVANCE OF COMMENCING THE WORK, OR AS REQUIRED BY SAID PERMITS.
- 9) THE CONTRACTOR SHALL, AT THE TIME OF BIDDING, AND, THROUGHOUT THE PERIOD OF THE CONTRACT, BE LICENSED IN THE STATE OF UTAH AND SHALL BE BONDABLE FOR AN AMOUNT EQUAL TO OR GREATER THAN THE AMOUNT BID AND TO DO THE TYPE OF WORK CONTEMPLATED IN THE PLANS AND SPECIFICATIONS.
- 10) CONTRACTOR SHALL INSPECT THE SITE OF THE WORK PRIOR TO BIDDING TO SATISFY THEMSELVES BY PERSONAL EXAMINATION OR BY SUCH OTHER MEANS AS THEY MAY PREFER, OF THE LOCATION OF THE PROPOSED WORK, AND OF THE ACTUAL CONDITIONS OF, AND AT, THE SITE OF WORK. IF, DURING THE COURSE OF THEIR EXAMINATION, A BIDDER FINDS FACTS OR CONDITIONS WHICH APPEAR TO THEM TO BE IN CONFLICT WITH THE LETTER OR SPIRIT OF THE PROJECT PLANS AND SPECIFICATIONS, THEY SHALL CONTACT THE ENGINEER FOR ADDITIONAL INFORMATION AND EXPLANATION BEFORE SUBMITTING THEIR BID. SUBMISSION OF A BID BY THE CONTRACTOR SHALL CONSTITUTE ACKNOWLEDGMENT THAT, IF AWARDED THE CONTRACT,

THEY HAVE RELIED AND ARE RELYING ON THEIR OWN EXAMINATION OF (1) THE SITE OF THE WORK, (2) ACCESS TO THE SITE, AND (3) ALL OTHER DATA AND MATTERS REQUISITE TO THE FULFILLMENT OF THE WORK AND ON THEIR OWN KNOWLEDGE OF EXISTING FACILITIES ON AND IN THE VICINITY OF THE SITE OF THE WORK TO BE CONSTRUCTED UNDER THIS CONTRACT. THE INFORMATION PROVIDED BY THE OWNER OR THE ENGINEER IS NOT INTENDED TO BE A SUBSTITUTE FOR, OR A SUPPLEMENT TO THE INDEPENDENT VERIFICATION BY THE CONTRACTOR TO THE EXTENT SUCH INDEPENDENT INVESTIGATION OF SITE CONDITIONS IS DEEMED NECESSARY OR DESIRABLE BY THE CONTRACTOR. CONTRACTOR SHALL ACKNOWLEDGE THAT THEY HAVE NOT RELIED SOLELY UPON OWNER OR ENGINEER FURNISHED INFORMATION REGARDING SITE CONDITIONS IN PREPARING AND SUBMITTING THEIR BID.

- 11) THE CONTRACTOR SHALL PROVIDE ALL LIGHTS, BARRICADES, SIGNS,
- FLAGMEN OR OTHER DEVICES NECESSARY FOR PUBLIC SAFETY. 12) THE CONTRACTOR SHALL BE RESPONSIBLE TO PROVIDE ALL WATER, POWER, SANITARY FACILITIES AND TELEPHONE SERVICES AS REQUIRED FOR THE CONTRACTORS USE DURING CONSTRUCTION.
- 13) THE CONTRACTOR SHALL BE HELD RESPONSIBLE FOR ANY FIELD CHANGES MADE WITHOUT PRIOR WRITTEN AUTHORIZATION FROM THE OWNER AND/OR ENGINEER.
- 14) THE CONTRACTOR SHALL EXERCISE DUE CAUTION AND SHALL CAREFULLY PRESERVE BENCH MARKS, CONTROL POINTS, SECTION CORNERS, REFERENCE POINTS AND ALL SURVEY STAKES, AND SHALL BEAR ALL EXPENSES FOR REPLACEMENT AND/OR ERRORS CAUSED BY UNNECESSARY LOSS OR DISTURBANCE.
- 15) THE CONTRACTOR AGREES THAT:
  - A) THEY SHALL BE RESPONSIBLE TO CLEAN THE JOB SITE AT THE END OF EACH DAY.
  - B) THEY SHALL BE RESPONSIBLE TO REMOVE AND DISPOSE OF ALL TRASH, SCRAP AND UNUSED MATERIAL AT THEIR OWN EXPENSE IN A TIMELY MANNER.
  - C) THEY SHALL BE RESPONSIBLE TO MAINTAIN THE SITE IN A NEAT, SAFE AND ORDERLY MANNER AT ALL TIMES.
  - D) THEY SHALL BE RESPONSIBLE TO KEEP MATERIALS, EQUIPMENT, AND TRASH OUT OF THE WAY OF OTHER CONTRACTORS SO AS NOT TO DELAY THE JOB. FAILURE TO DO SO WILL RESULT IN A DEDUCTION FOR THE COST OF CLEAN UP FROM THE FINAL PAYMENT.
  - E) THEY SHALL BE RESPONSIBLE FOR THEIR OWN SAFETY, TRAFFIC CONTROL, PERMITS, RETESTING AND RE-INSPECTIONS AT THEIR OWN EXPENSE.
- 16) THE CONTRACTOR SHALL ASSUME SOLE AND COMPLETE RESPONSIBILITY FOR JOBSITE CONDITIONS DURING THE COURSE OF CONSTRUCTION OF THIS PROJECT, INCLUDING SAFETY OF ALL PERSONS AND PROPERTY. THIS REQUIREMENT SHALL APPLY CONTINUOUSLY AND NOT BE LIMITED TO NORMAL WORKING HOURS. THE CONTRACTOR SHALL DEFEND, INDEMNIFY AND HOLD THE OWNER AND ENGINEER HARMLESS FROM ANY AND ALL LIABILITY. REAL OR ALLEGED, IN CONNECTION WITH THE PERFORMANCE OF WORK ON THIS PROJECT, EXCEPTING FOR LIABILITY ARISING FROM THE SOLE AND GROSS NEGLIGENCE OF THE OWNER OR THE ENGINEER.
- 17) DUST CONTROL SHALL BE PROVIDED AT ALL TIMES, AT THE CONTRACTOR'S EXPENSE, TO MINIMIZE ANY DUST NUISANCE AND SHALL BE IN ACCORDANCE WITH THE REQUIREMENTS OF SALT LAKE
- 18) WHEN CONSTRUCTION STAKING IS REQUIRED THE CONTRACTOR SHALL NOTIFY THE ENGINEER/LAND SURVEYOR 1 WEEK IN ADVANCE OF THE NEED FOR STAKING. ANY STAKING REQUESTED BY THE CONTRACTOR OR THEIR SUBCONTRACTORS THAT IS ABOVE AND BEYOND STANDARD STAKING NEEDS, INCLUDING RE-STAKING WILL BE SUBJECT TO A CONTRACTOR CHANGE ORDER AND THE IMPACT COSTS OF WORK PERFORMED
- 19) FOR ALL WORK WITHIN PUBLIC RIGHTS-OF-WAYS OR EASEMENTS. THE CONTRACTOR SHALL PRESERVE THE INTEGRITY AND LOCATION OF ANY AND ALL PUBLIC UTILITIES AND PROVIDE THE NECESSARY CONSTRUCTION TRAFFIC CONTROL. CONTRACTOR SHALL, THROUGH THE ENCROACHMENT PERMIT PROCESS, VERIFY WITH THE NECESSARY REGULATORY AGENCIES, THE NEED FOR ANY TRAFFIC ROUTING PLAN. IF PLAN IS REQUIRED, CONTRACTOR SHALL PROVIDE PLAN AND RECEIVE PROPER APPROVALS PRIOR TO BEGINNING CONSTRUCTION.
- 20) THE CONTRACTOR SHALL BE RESPONSIBLE FOR ADEQUATELY SCHEDULING INSPECTION AND TESTING OF ALL FACILITIES CONSTRUCTED UNDER THIS CONTRACT. ALL TESTING SHALL CONFORM TO THE REGULATORY AGENCY'S STANDARD SPECIFICATIONS. ALL RE-TESTING AND/OR RE-INSPECTION SHALL BE PAID FOR BY THE CONTRACTOR.
- 21) IF EXISTING FEATURES NEED TO BE DISTURBED AND/OR REMOVED FOR THE PROPER PLACEMENT OF IMPROVEMENTS TO BE CONSTRUCTED BY THESE PLANS, THE CONTRACTOR SHALL BE RESPONSIBLE FOR PROTECTING EXISTING FEATURES FROM DAMAGE. COST OF REPLACING OR REPAIRING EXISTING FEATURES SHALL BE INCLUDED IN THE BID PRICE FOR ITEMS REQUIRING REMOVAL AND/OR REPLACEMENT

22) THE CONTRACTOR SHALL MAINTAIN A NEATLY MARKED SET OF

FULL-SIZE AS-BUILT DRAWINGS SHOWING THE FINAL LOCATION AND LAYOUT OF ALL FACILITIES. AS-BUILT DRAWINGS SHALL REFLECT CHANGE ORDERS, ACCOMMODATIONS, AND ADJUSTMENTS TO ALL IMPROVEMENTS CONSTRUCTED. WHERE NECESSARY, SUPPLEMENTAL DRAWINGS SHALL BE PREPARED AND SUBMITTED BY THE CONTRACTOR. PRIOR TO ACCEPTANCE OF THE PROJECT, THE CONTRACTOR SHALL DELIVER TO THE ENGINEER, ONE SET OF NEATLY MARKED AS-BUILT DRAWINGS SHOWING THE INFORMATION REQUIRED ABOVE. AS-BUILT DRAWINGS SHALL BE REVIEWED AND THE COMPLETE AS-BUILT DRAWING SET SHALL BE CURRENT WITH ALL CHANGES AND DEVIATIONS REDLINED AS A PRECONDITION TO THE FINAL PROGRESS PAYMENT APPROVAL AND/OR FINAL ACCEPTANCE.

- 23) WORK IN EASEMENT AND/OR RIGHTS-OF-WAY IS SUBJECT TO THE APPROVAL AND ACCEPTANCE OF THE REGULATORY AGENCY RESPONSIBLE FOR OPERATION AND/OR MAINTENANCE OF SAID EASEMENT AND/OR RIGHTS-OF-WAY.
- 24) NO ALLOWANCE WILL BE MADE FOR DISCREPANCIES OR OMISSIONS THAT CAN BE EASILY OBSERVED. VERIFY ALL EXISTING CONDITIONS BEFORE BIDDING, AND ANSWER ANY QUESTIONS BEFORE CONSTRUCTION.
- 25) FURNISH, MAINTAIN, AND RESTORE ALL MONUMENTS AND MONUMENT REFERENCE MARKS WITHIN THE PROJECT SITE. CONTACT THE CITY OR COUNTY SURVEYOR FOR MONUMENT LOCATIONS AND CONSTRUCTION
- 26) PROVIDE A CONSTRUCTION SCHEDULE IN ACCORDANCE WITH CITY, COUNTY, AND STATE REGULATIONS FOR WORKING IN THE PUBLIC WAY. 27) FURNISH ALL MATERIALS TO COMPLETE THE PROJECT.
- 28) TRAFFIC CONTROL IS TO CONFORM TO THE CURRENT MUTCD AND UDOT STANDARDS.
- 29) CONTRACTOR SHALL BE RESPONSIBLE FOR ANY DAMAGE TO ADJACENT SURFACE IMPROVEMENTS. 30) ALL EXISTING ASPHALT WILL BE SAW CUT IN NEAT STRAIGHT LINES BY
- THE CONTRACTOR PRIOR TO EXCAVATION. 31) STRIPING WILL BE PER THE PLANS AND/OR AS DIRECTED BY THE
- OWNER'S REPRESENTATIVE. STRIPING TO INCLUDE HANDICAP INSIGNIAS, SIGNS, CROSS-HATCHING, DIRECTION ARROWS, ETC. AS SHOWN OR AS DIRECTED.

#### GENERAL CLEARING AND GRADING NOTES:

- CLEARING, GRUBBING AND DISPOSAL OF VEGETATIVE MATERIAL NEEDS TO BE IN ACCORDANCE WITH STATE AND COUNTY REGULATIONS, WHICH APPLY TO SOLID WASTE.
- 2) CONTRACTOR SHALL PERFORM EARTHWORK IN ACCORDANCE WITH SALT LAKE CITY STANDARD SPECIFICATIONS AND CONSTRUCTION STANDARDS, EROSION, SEDIMENT, RE-VEGETATION REQUIREMENTS, AND THE SWPP PLAN AS REQUIRED BY THE STATE OF UTAH, DEPARTMENT OF ENVIRONMENTAL QUALITY AND DIVISION OF AIR QUALITY.
- THE CONTRACTOR WILL PERFORM EARTHWORK IN ACCORDANCE WITH TECHNICAL SPECIFICATIONS OUTLINED IN THE CONSTRUCTION STANDARDS AND THE RECOMMENDED EARTHWORK SPECIFICATIONS FOUND IN THE GEOTECHNICAL REPORT PROVIDED BY CMT ENGINEERING DATED MAY 22, 2018.
- 4) SEDIMENTATION BMP'S SHOWN ON THE EROSION CONTROL AND SEDIMENT CONTROL PLANS (STORM WATER POLLUTION PREVENTION PLAN) TO BE INSTALLED WITHIN THE SAME WORKING DAY THE LAND DISTURBANCE OCCURS.
- 5) DUST CONTROL BMP'S ARE TO BE ON SITE AND IMPLEMENTED AS SOON AS LAND DISTURBANCE OCCURS.
- THE EXISTING TOPOGRAPHY SHOWN ON THESE PLANS IS BASED ON DRAWINGS AND A TOPOGRAPHIC SURVEY PERFORMED BY CRS ENGINEERS. IF THE EXISTING GRADE IS DIFFERENT FROM WHAT IS SHOWN ON THE GRADING PLAN, STOP WORK AND CONTACTORS ENGINEERS. WORK IS TO REMAIN STOPPED UNTIL THE ENGINEER PROVIDES A WRITTEN NOTICE TO RESUME WORK.
- 7) THE CONTRACTOR IS RESPONSIBLE FOR MAINTAINING THE STREETS, STORM DRAINS, CHANNELS, DITCHES, AND SWALES FREE FROM DEBRIS, SOIL, MUD, OR OTHER MATERIAL THAT WOULD CAUSE A PUBLIC SAFETY CONCERN OR VIOLATE ANY CITY, STATE, OR FEDERAL LAWS.
- BMP'S ARE TO BE IN PLACE AND MAINTAINED UNTIL WRITTEN NOTIFICATION IS RECEIVED FROM SALT LAKE CITY
- 9) IF DISTURBANCE OCCURS OUTSIDE THE LIMITS OF DISTURBANCE, WORK WILL STOP AND REMAIN STOPPED UNTIL A WRITTEN RESPONSE IS RECEIVED FROM THE ENGINEER.
- 10) THE CONTRACTOR SHALL REMOVE ALL VEGETATION AND DELETERIOUS MATERIALS FROM THE SITE UNLESS NOTED OTHERWISE.
- 11) NATURAL VEGETATION AND SOIL COVER SHALL NOT BE DISTURBED PRIOR TO ACTUAL CONSTRUCTION OF A REQUIRED FACILITY OR IMPROVEMENT. MASS CLEARING OF THE SITE IN ANTICIPATION OF CONSTRUCTION SHALL BE AVOIDED. CONSTRUCTION TRAFFIC SHALL BE LIMITED TO ONE APPROACH TO SITE. THE APPROACH SHALL BE DESIGNATED BY THE OWNER.

#### **GENERAL UTILITY NOTES**

- 1) THE LOCATIONS OF UNDERGROUND FACILITIES SHOWN ON THESE PLANS ARE BASED ON FIELD SURVEYS AND LOCAL UTILITY COMPANY RECORDS. IT SHALL BE THE CONTRACTORS FULL RESPONSIBILITY TO CONTACT THE VARIOUS UTILITY COMPANIES TO LOCATE THEIR FACILITIES PRIOR TO PROCEEDING WITH CONSTRUCTION. NO ADDITIONAL COMPENSATION SHALL BE PAID TO THE CONTRACTOR FOR DAMAGE AND REPAIR TO THESE FACILITIES CAUSED BY CONTRACTORS WORK FORCE.
- START AT THE LOW END OF ALL GRAVITY FED LINES AND WORK UPHILL. FAILURE TO COMPLY WITH THIS NOTE SHALL RELEASE THE CIVIL ENGINEER OF ALL LIABILITY.
- 3) CONTRACTOR SHALL LAYOUT AND POTHOLE FOR ALL POTENTIAL CONFLICTS WITH UTILITY LINES ON OR OFF SITE AS REQUIRED PRIOR TO ANY CONSTRUCTION.
- 4) STORM DRAIN SEE SALT LAKE CITY STANDARDS & SPECIFICATIONS FOR ALL DETAILS & SPECIFICATIONS GOVERNING THE CONSTRUCTION & INSPECTION OF THE STORM DRAIN & APPURTENANCES WITHIN THE PUBLIC RIGHT-OF-WAY AS SHOWN ON THIS PLAN. SEE THE DETAILS PROVIDED ON THIS SET OF DRAWINGS FOR ALL OTHER STORM DRAIN CONSTRUCTION. APWA STANDARDS WILL BE USED IN THE ABSENCE OF ANY STANDARDS AND DETAILS.
- ALL DIMENSIONS AND GRADES OF EXISTING STORM DRAIN PIPES, BOX CULVERTS, STRUCTURES, ETC. SHOWN ON THE PLANS SHALL BE VERIFIED BY THE CONTRACTOR PRIOR TO CONSTRUCTION. NOTIFY THE ENGINEER IF ANY DISCREPANCIES EXIST. PRIOR TO PROCEEDING WITH CONSTRUCTION FOR NECESSARY PLAN OR GRADE CHANGES. NO EXTRA COMPENSATION SHALL BE PAID TO THE CONTRACTOR FOR WORK HAVING TO BE REDONE DUE TO THE DIMENSIONS OR GRADES SHOWN INCORRECTLY ON THESE PLANS, IF SUCH NOTIFICATION HAS NOT BEEN GIVEN.
- 6) THESE PLANS SHOW THE LOCATION OF POWER, NATURAL GAS, AND COMMUNICATIONS UTILITIES, BUT ARE NOT DESIGN DRAWINGS FOR THE RELOCATION OR REMOVAL OF EXISTING DRY UTILITIES, NOR FOR ANY NEW DRY UTILITY STUBS. CONTRACTOR IS TO SUBMIT SITE PLAN TO DRY UTILITIES FOR DESIGN OF SERVICE CONNECTIONS TO BUILDING. ACTUAL CONSTRUCTION OF SAID SERVICES TO BE DONE BY RESPECTIVE UTILITY PROVIDERS.
- 7) VERIFY DEPTHS OF UTILITIES IN THE FIELD BY POT HOLING A MINIMUM OF 300 FEET AHEAD OF PIPELINE CONSTRUCTION TO AVOID CONFLICTS WITH DESIGNED PIPELINE GRADE AND ALIGNMENT. IF A CONFLICT ARISES RESULTING FROM THE CONTRACTOR'S NEGLIGENCE TO POTHOLE UTILITIES THE CONTRACTOR WILL BE REQUIRED TO RESOLVE THE CONFLICT WITHOUT ADDITIONAL COST OR CLAIM TO THE OWNER OR ENGINEER.
- 8) ALL DIMENSIONS, GRADES, AND UTILITY DESIGNS SHOWN ON THE PLANS SHALL BE VERIFIED BY THE CONTRACTOR PRIOR TO CONSTRUCTION. NOTIFY THE ENGINEER IF ANY DISCREPANCIES EXIST. PRIOR TO PROCEEDING WITH CONSTRUCTION FOR NECESSARY PLAN OR GRADE CHANGES. NO EXTRA COMPENSATION SHALL BE PAID TO THE CONTRACTOR FOR WORK HAVING TO BE REDONE DUE TO THE DIMENSIONS OR GRADES SHOWN INCORRECTLY ON THESE PLANS, IF SUCH NOTIFICATION HAS NOT BEEN GIVEN.
- 9) NO CHANGE IN DESIGN LOCATION OR GRADE WILL BE MADE BY THE CONTRACTOR WITHOUT THE WRITTEN APPROVAL OF THE PROJECT ENGINEER.
- 10) ALL EXISTING MANHOLES, WATER VALVES, CLEAN OUTS, ETC., ARE TO BE RAISED OR LOWERED TO GRADE.


#### FIRE CODE PLAN NOTES


- 1. CONSTRUCTION SHALL NOT COMMENCE UNTIL FIRE DEPARTMENT ACCESS ROADS ARE INSTALLED WITHIN 100 FEET OF ALL EXTERIOR WALLS OF THE FIRST FLOOR AND FIRE HYDRANTS ARE INSTALLED, AND REQUIRED FIRE FLOW IS PROVIDED. AS REQUIRED IN INTERNATIONAL FIRE CODE (IFC) SECTION 3312.1
- REQUIRED MEANS OF EGRESS AND FIRE PROTECTION SYSTEMS SHALL BE MAINTAINED DURING CONSTRUCTION AND DEMOLITION, REMODELING OR ALTERATIONS AND ADDITIONS TO THE BUILDING. FIRE PREVENTION BUREAU STAFF SHALL APPROVE REVIEW OF ANY EXITING ALTERATIONS. AS REQUIRED IN IFC SECTION 3311.2
- 3. ALL FIRE DEFERRED (IBC 107.3.4.1) SUBMITTAL ITEM(S) NEED TO BE SUBMITTED WITHIN A TIMELY MANNER (30 CALENDAR DAYS OF THE ORIGINAL BUILDING PERMIT ISSUANCE DATE). THE FINAL INSPECTION APPROVAL (IBC 110.3.10) CANNOT BE ISSUED AND NO BUILDING OR STRUCTURE CAN BE USED OR OCCUPIED (IBC 111.1) UNTIL ALL THE FIRE DEFERRED SUBMITTED ITEMS ARE APPROVED BY THE BUILDING AND FIRE OFFICIALS.

#### **ABBREVIATIONS**

APPROX	APPROXIMATE	LIN.	LINEAR
ASTM	AMERICAN SOCIETY FOR	LP	LOW POINT
	TESTING AND MATERIALS	MAX	MAXIMUM MATCH EVICTING ORANG
ANSI	AMERICAN NATIONAL	MEG	MATCH EXISTING GRADE
	STANDARDS INSTITUTE	MIN	MINIMUM
APWA	AMERICAN PUBLIC WORKS	MJ	MECHANICAL JOINT
	ASSOCIATION	N	NORTH
WWA	AMERICAN WATER WORKS	N/A	NOT APPLICABLE
	ASSOCIATION	NIC	NOT IN CONTACT
F	BLIND FLANGE	NO	NUMBER
LDG	BUILDING	NTS	NOT TO SCALE
)	CHORD LENGTH	OC	ON CENTER
TO C	CENTER TO CENTER	OD	OUTSIDE DIAMETER
B B	CHORD BEARING	OSHA	OCCUPATIONAL SAFETY
) 	CAST IRON		& HEALTH ADMINISTRATION
) L	CLASS	PE	PLAIN END
CLR	CLEAR	PG	PAGE
CMP	CORRUGATED METAL PIPE	PI	POINT OF INTERSECTION
CO	CLEANOUT	PJDI	PUSH-ON JOINT
CONC	CONCRETE		DUCTILE IRON
)  	DUCTILE IRON	PSF	POUNDS PER FOOT
)IM	DIMENSION	PSI	POUNDS PER SQUARE
	EAST		INCH
: :A	EDGE OF ASPHALT	PUE	PUBLIC UTILITY
			EASEMENT
:G :L	EXISTING GRADE	PVC	POLYVINYL CHLORIDE
	ELEVATION	RCP	REINFORCED CONCRETE
LEV	ELEVATION EDGE OF DAVISMENT		PIPE
P	EDGE OF PAVEMENT	R	RADIUS
W	EACH WAY	RT	RIGHT
X	EXISTING	RJ	RESTRAINED JOINT
-G	FINISH GRADE	S	SOUTH
H	FIRE HYDRANT	SEC	SECTION
L	FLOWLINE	SS	SANITARY SEWER
LG	FLANGE	STA	STATION
T.	FEET	T	TOP
IDPE	HIGH DENSITY	TB	THRUST BLOCK
	POLYETHYLENE PIPE	TBA	TO BE ABANDONED
IORIZ	HORIZONTAL	TBC	TOP BACK CURB
IP .	HIGH POINT	TC	TOP OF CONCRETE
)	INSIDE DIAMETER	TYP	TYPICAL
<u>.</u>	INVERT ELEVATION	UDOT	UTAH DEPARTMENT OF
٧V	INVERT	0001	TRANSPORTATION
R	IRON ROD	VERT	VERTICAL
RR	IRRIGATION	W	WATER
T	LEFT	W	WEST
	LENGTH	W/	WITH
.BS	POUNDS	wwF	WELDED WIRE FABRIC
F.	LINEAR FEET	V V V V 🗀	WELDED WIKE PADRIC

100%

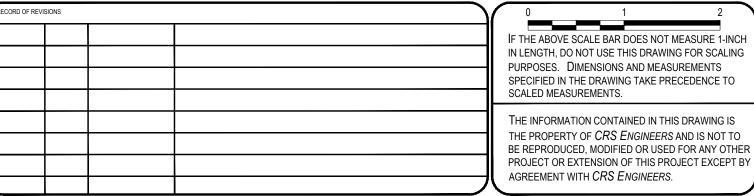

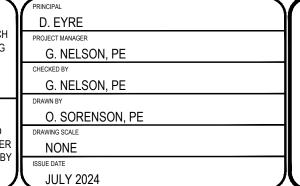





SISDAC UTAH ARCH NEXUS-SAMOAN CHURCH GENERAL NOTES AND ABBREVIATIONS


18065C C-002


1624 S 1000 W


SALT LAKE CITY, UTAH

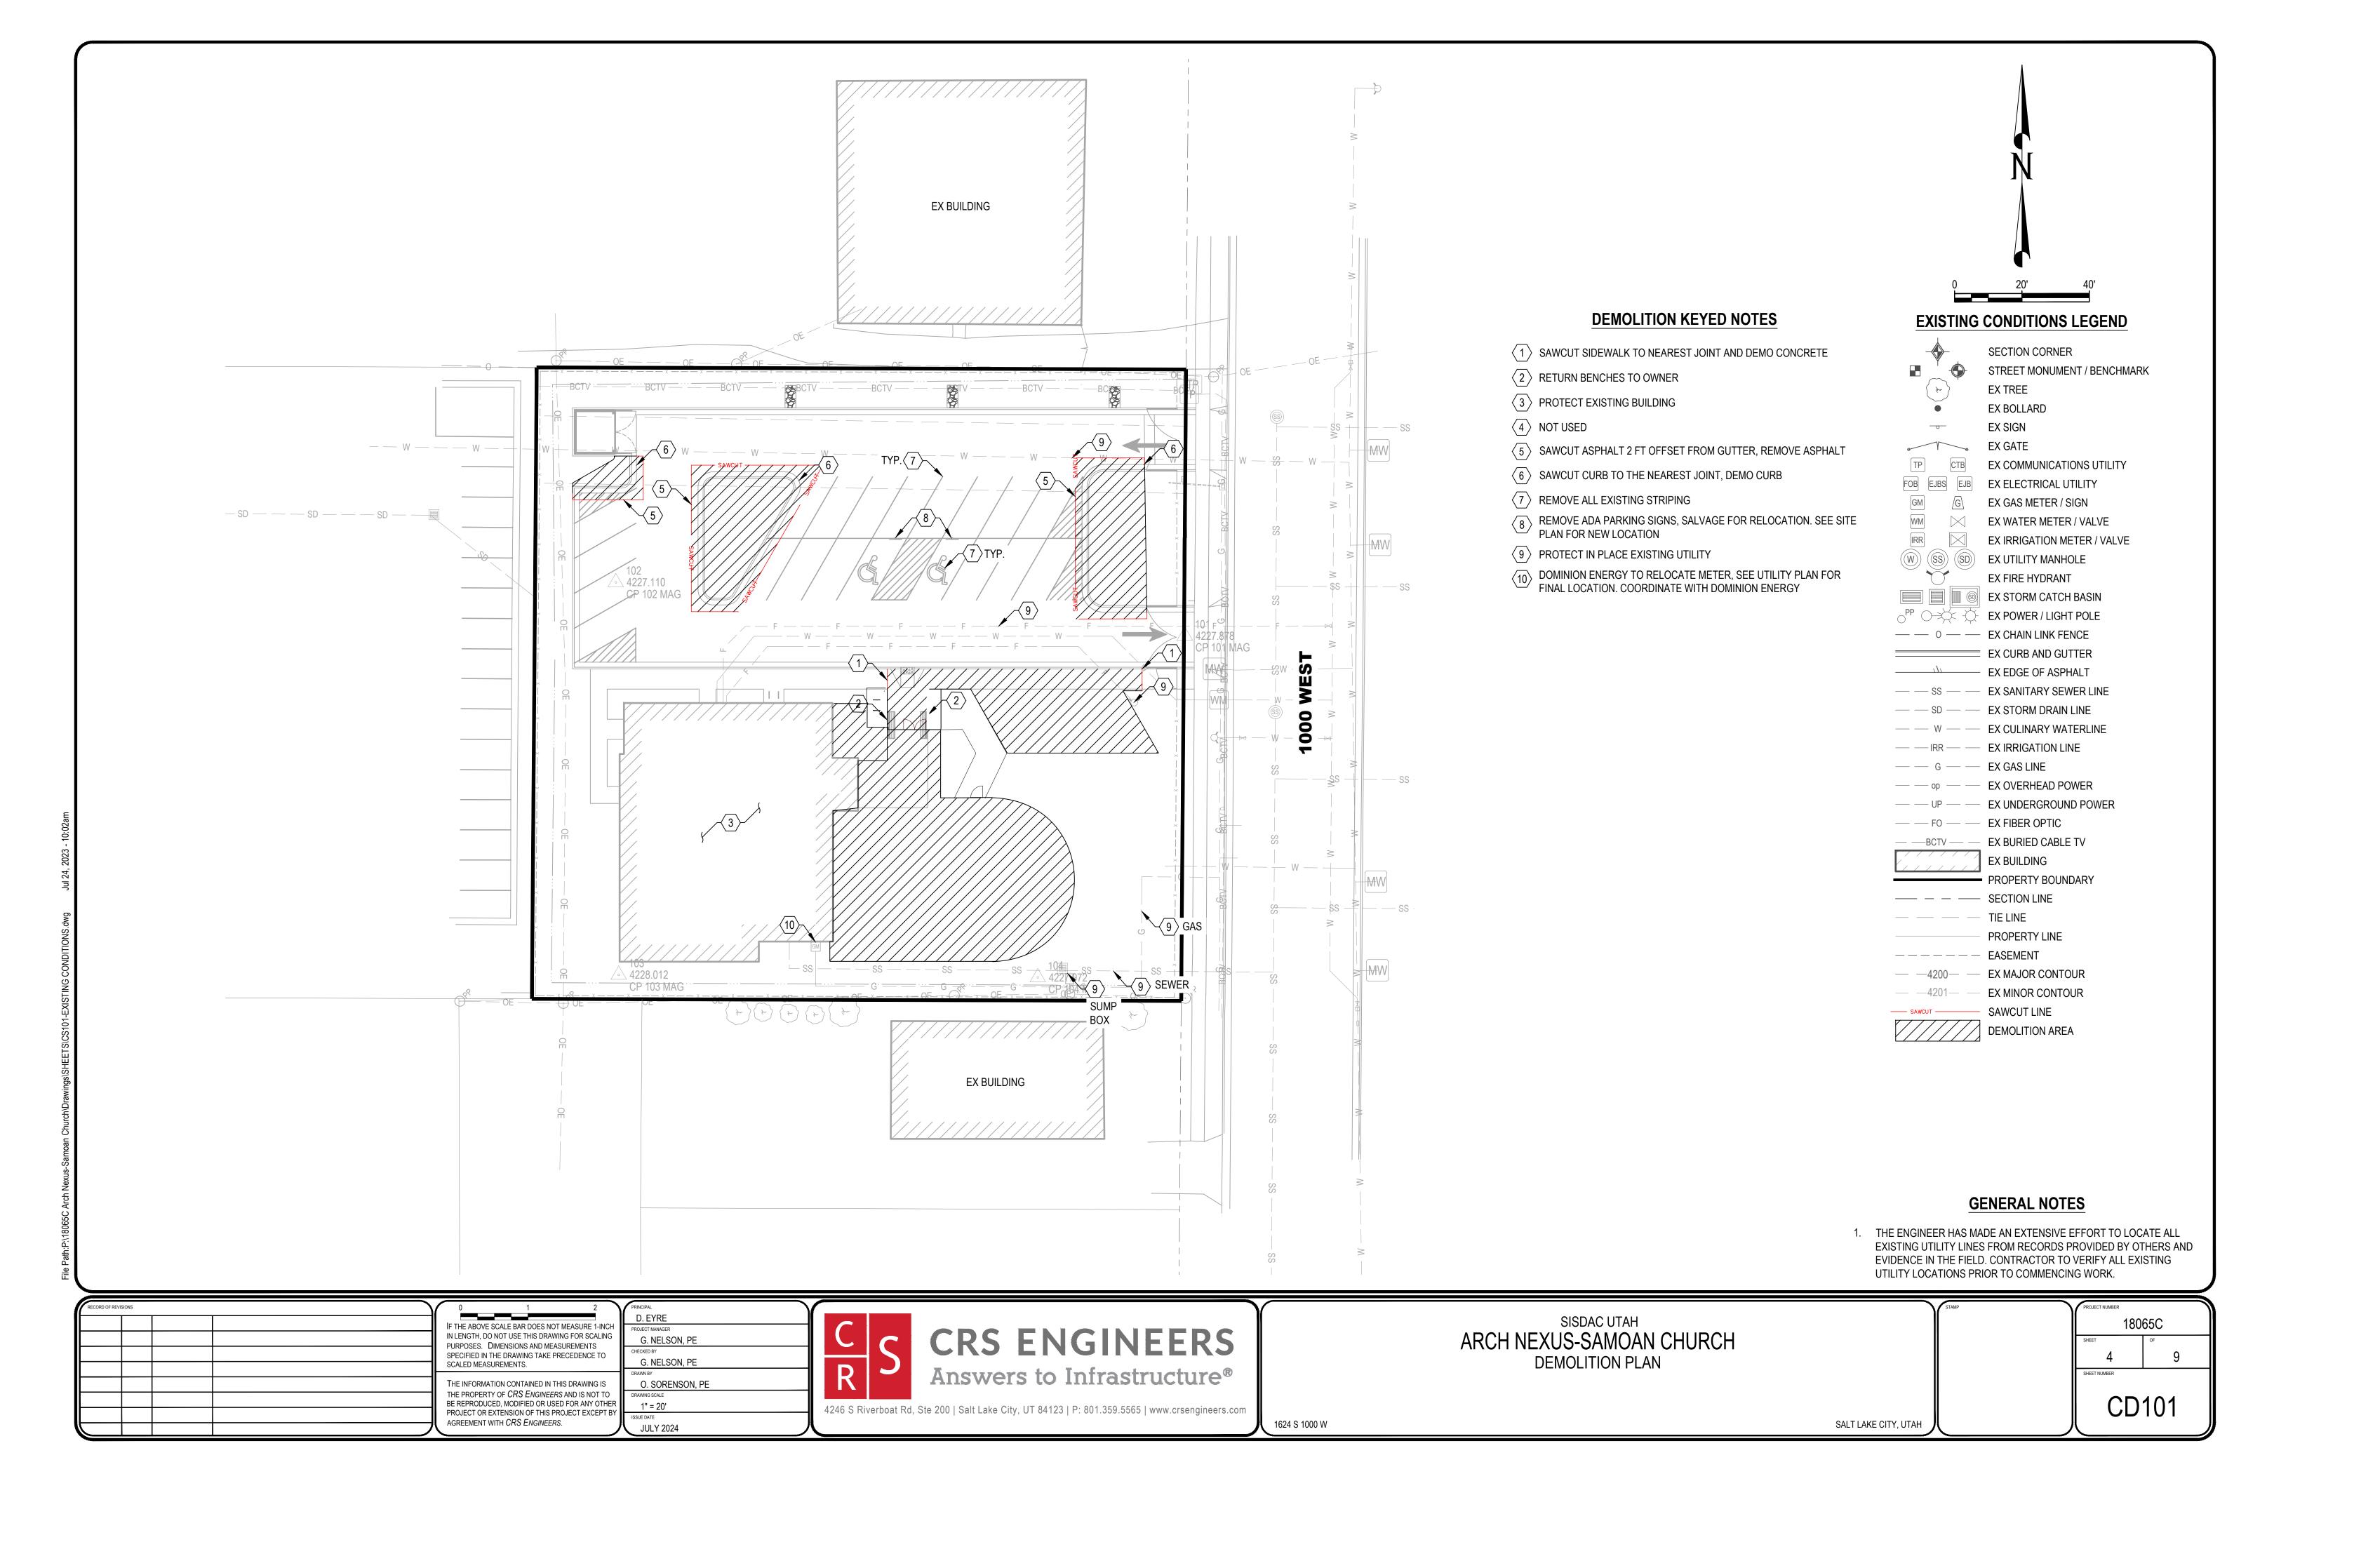


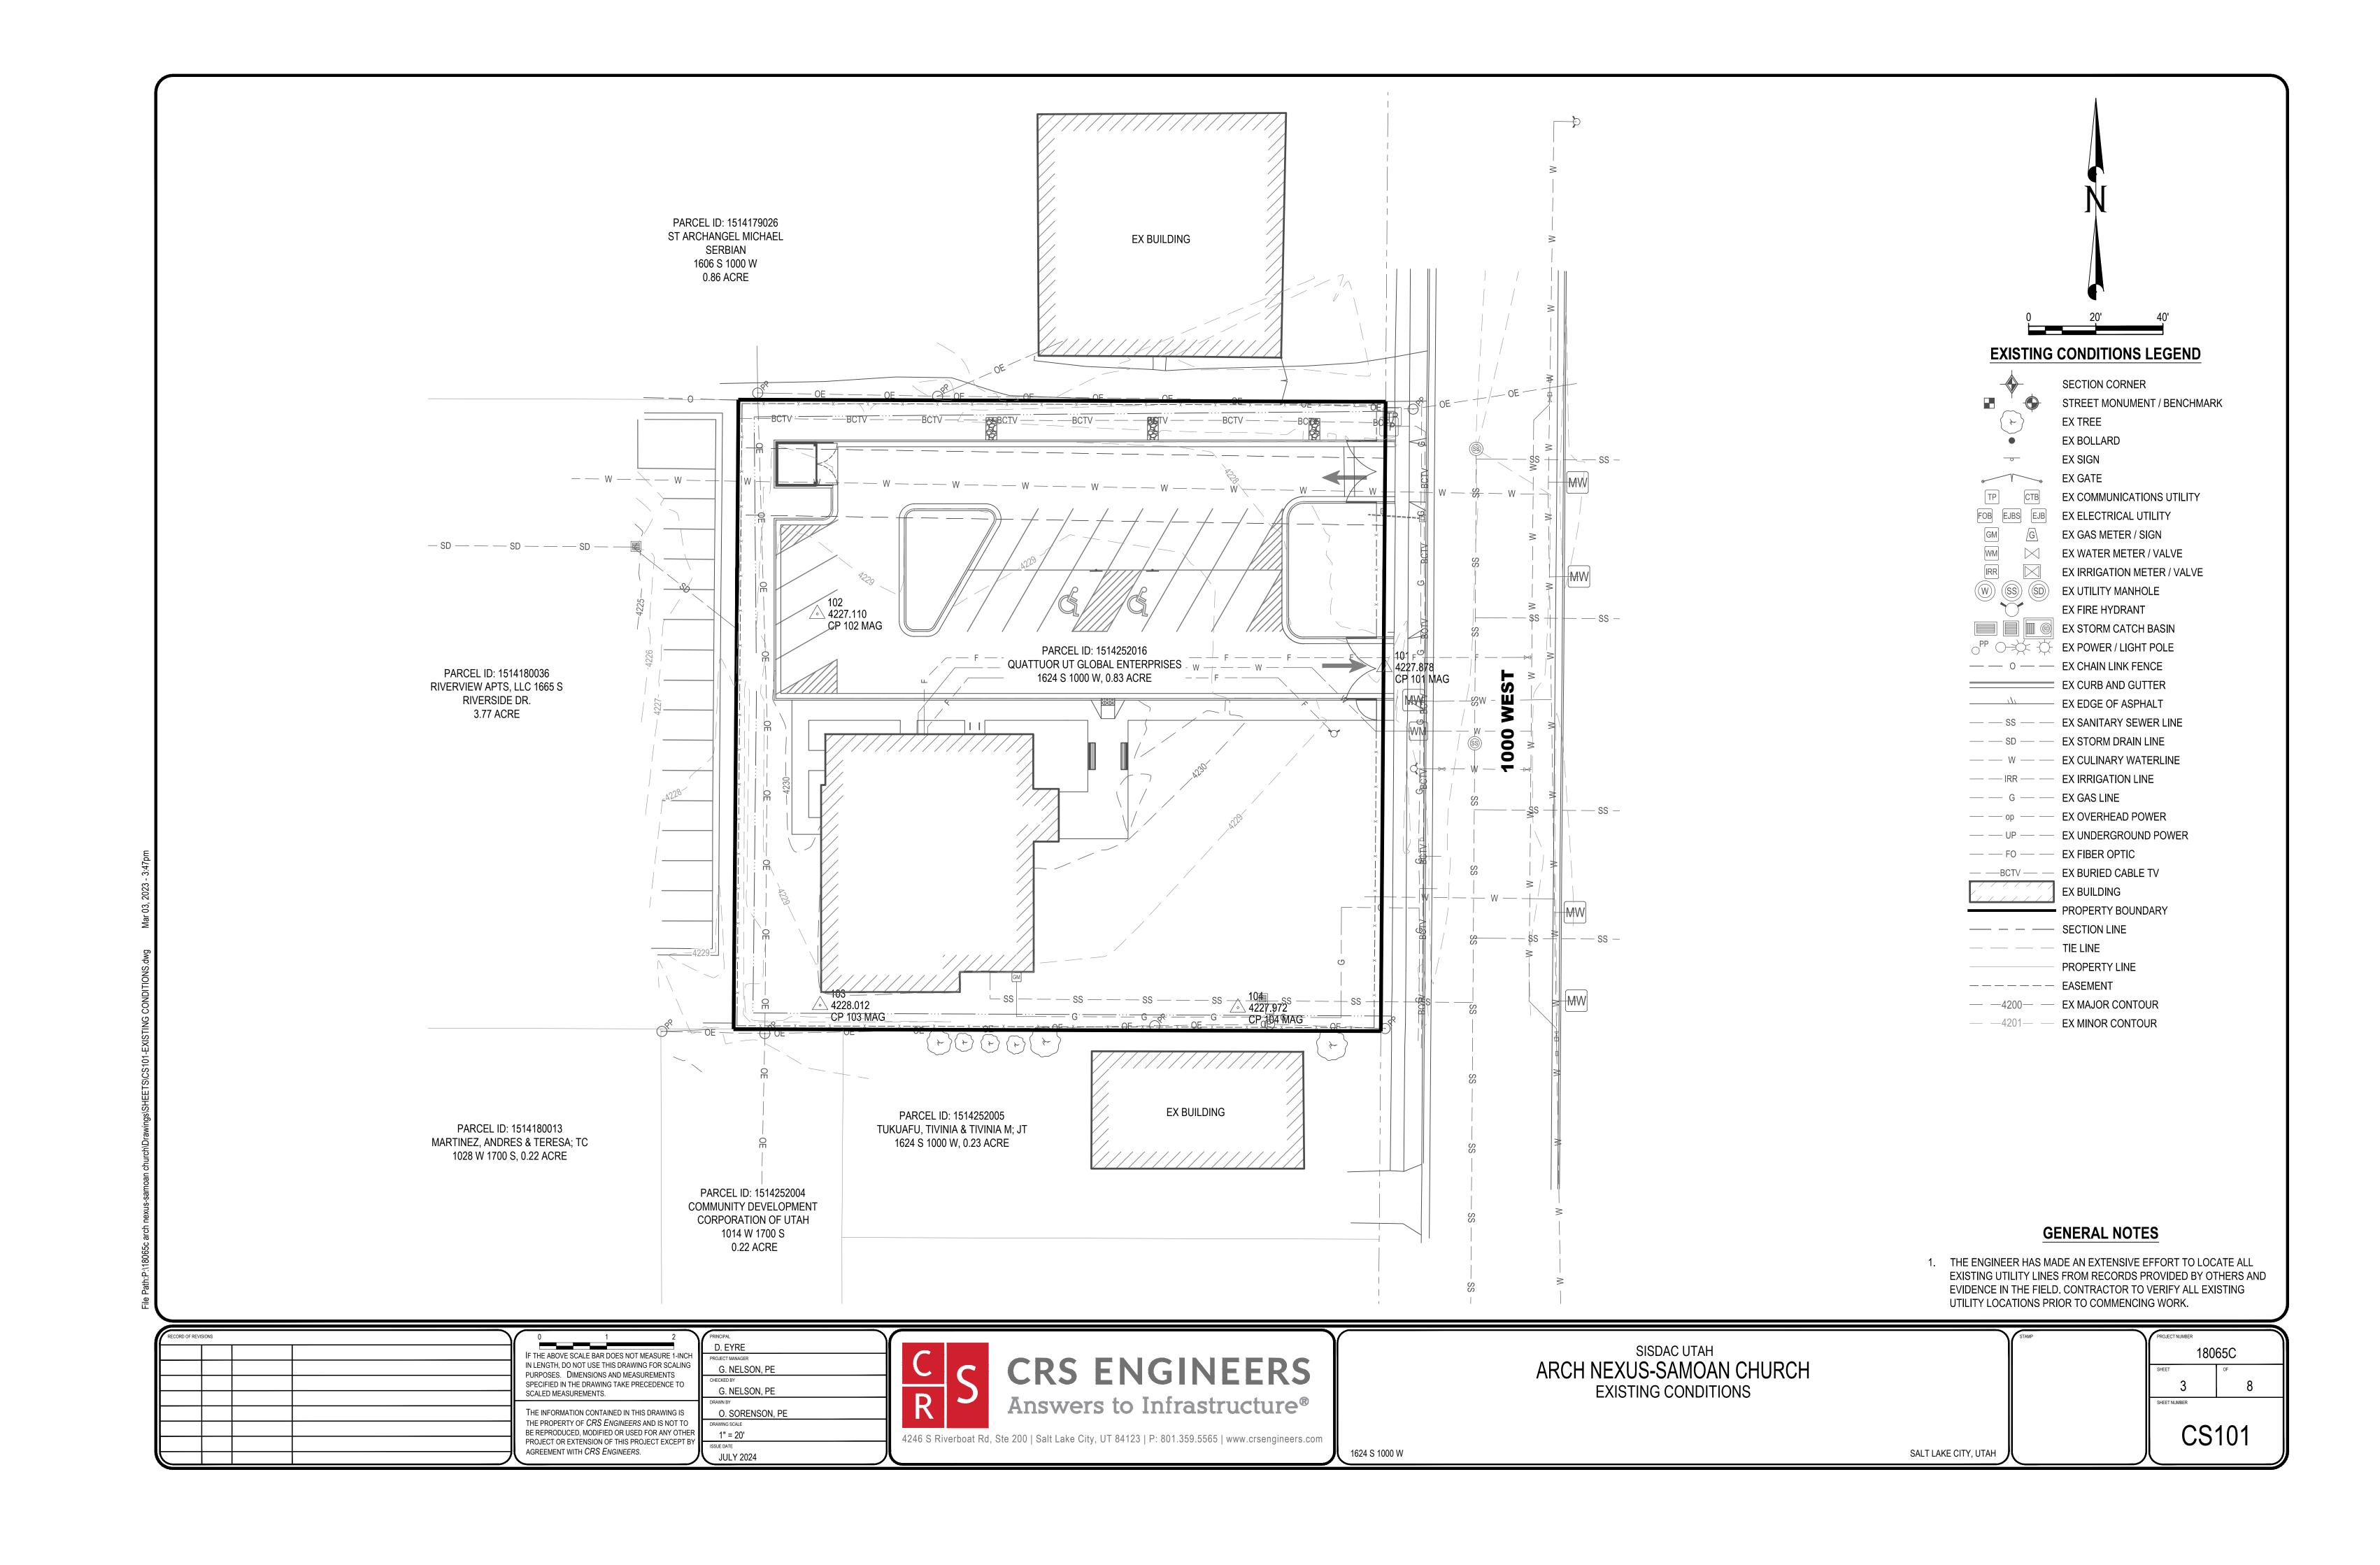

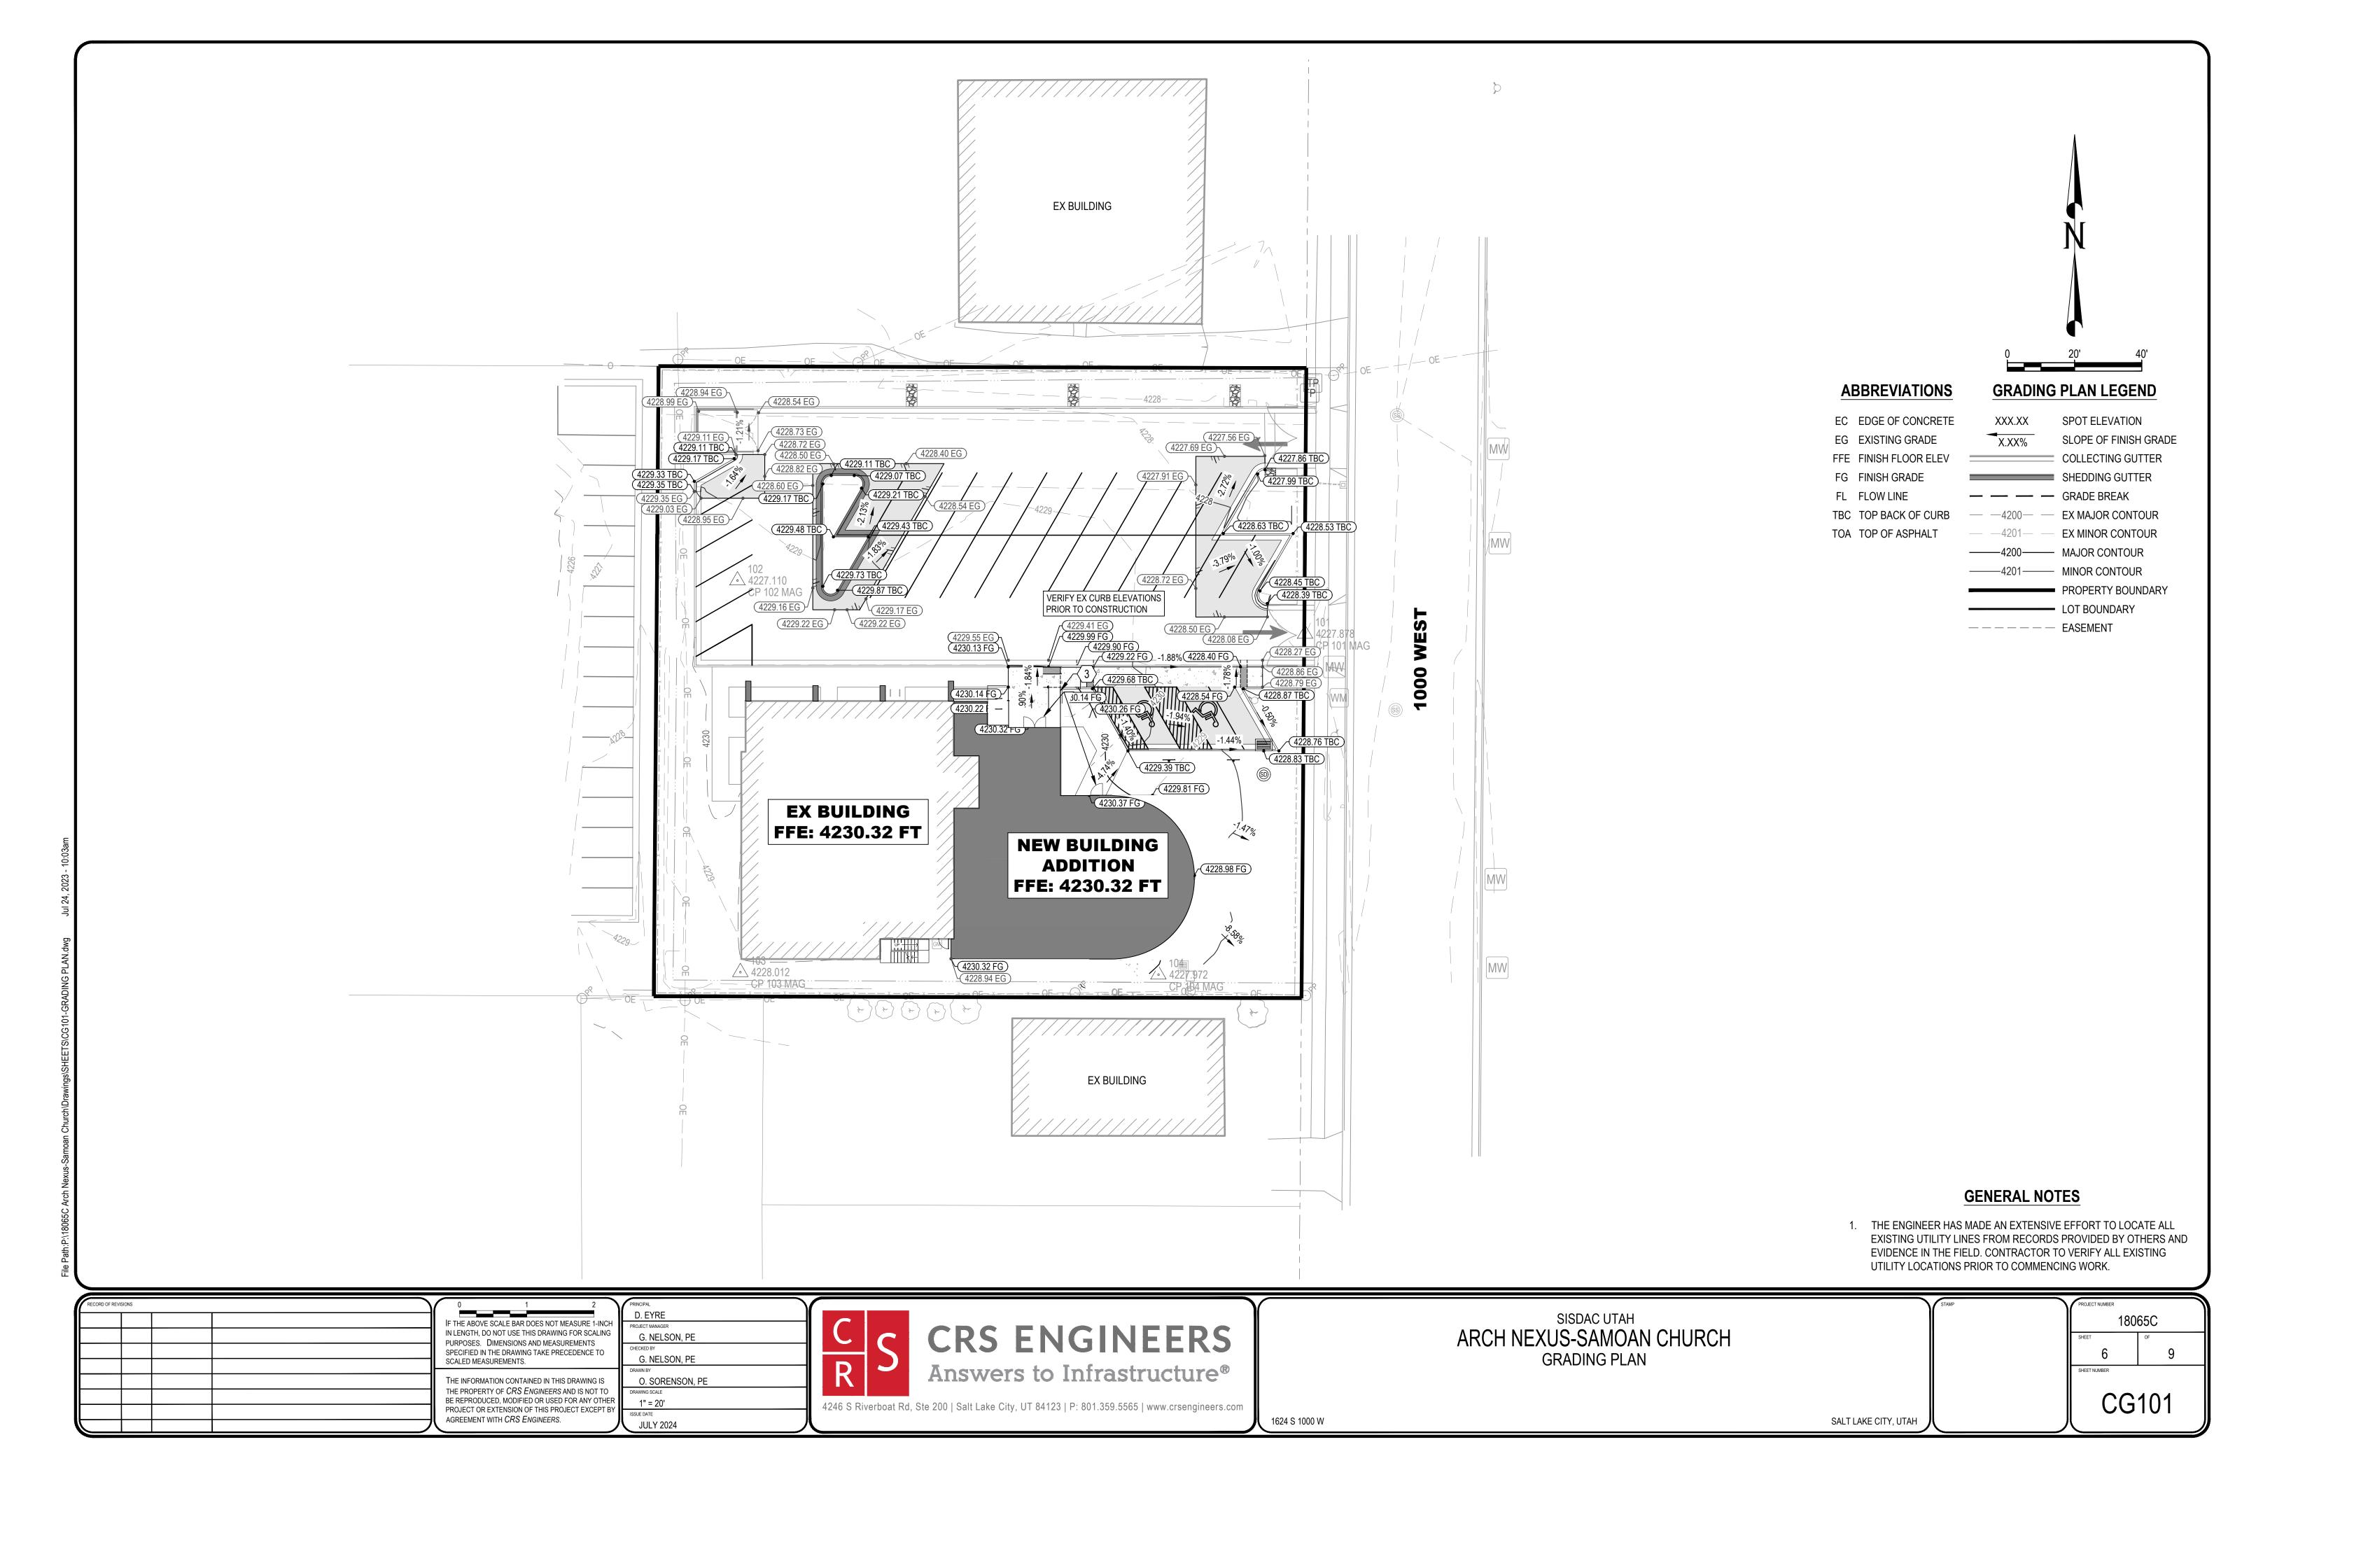

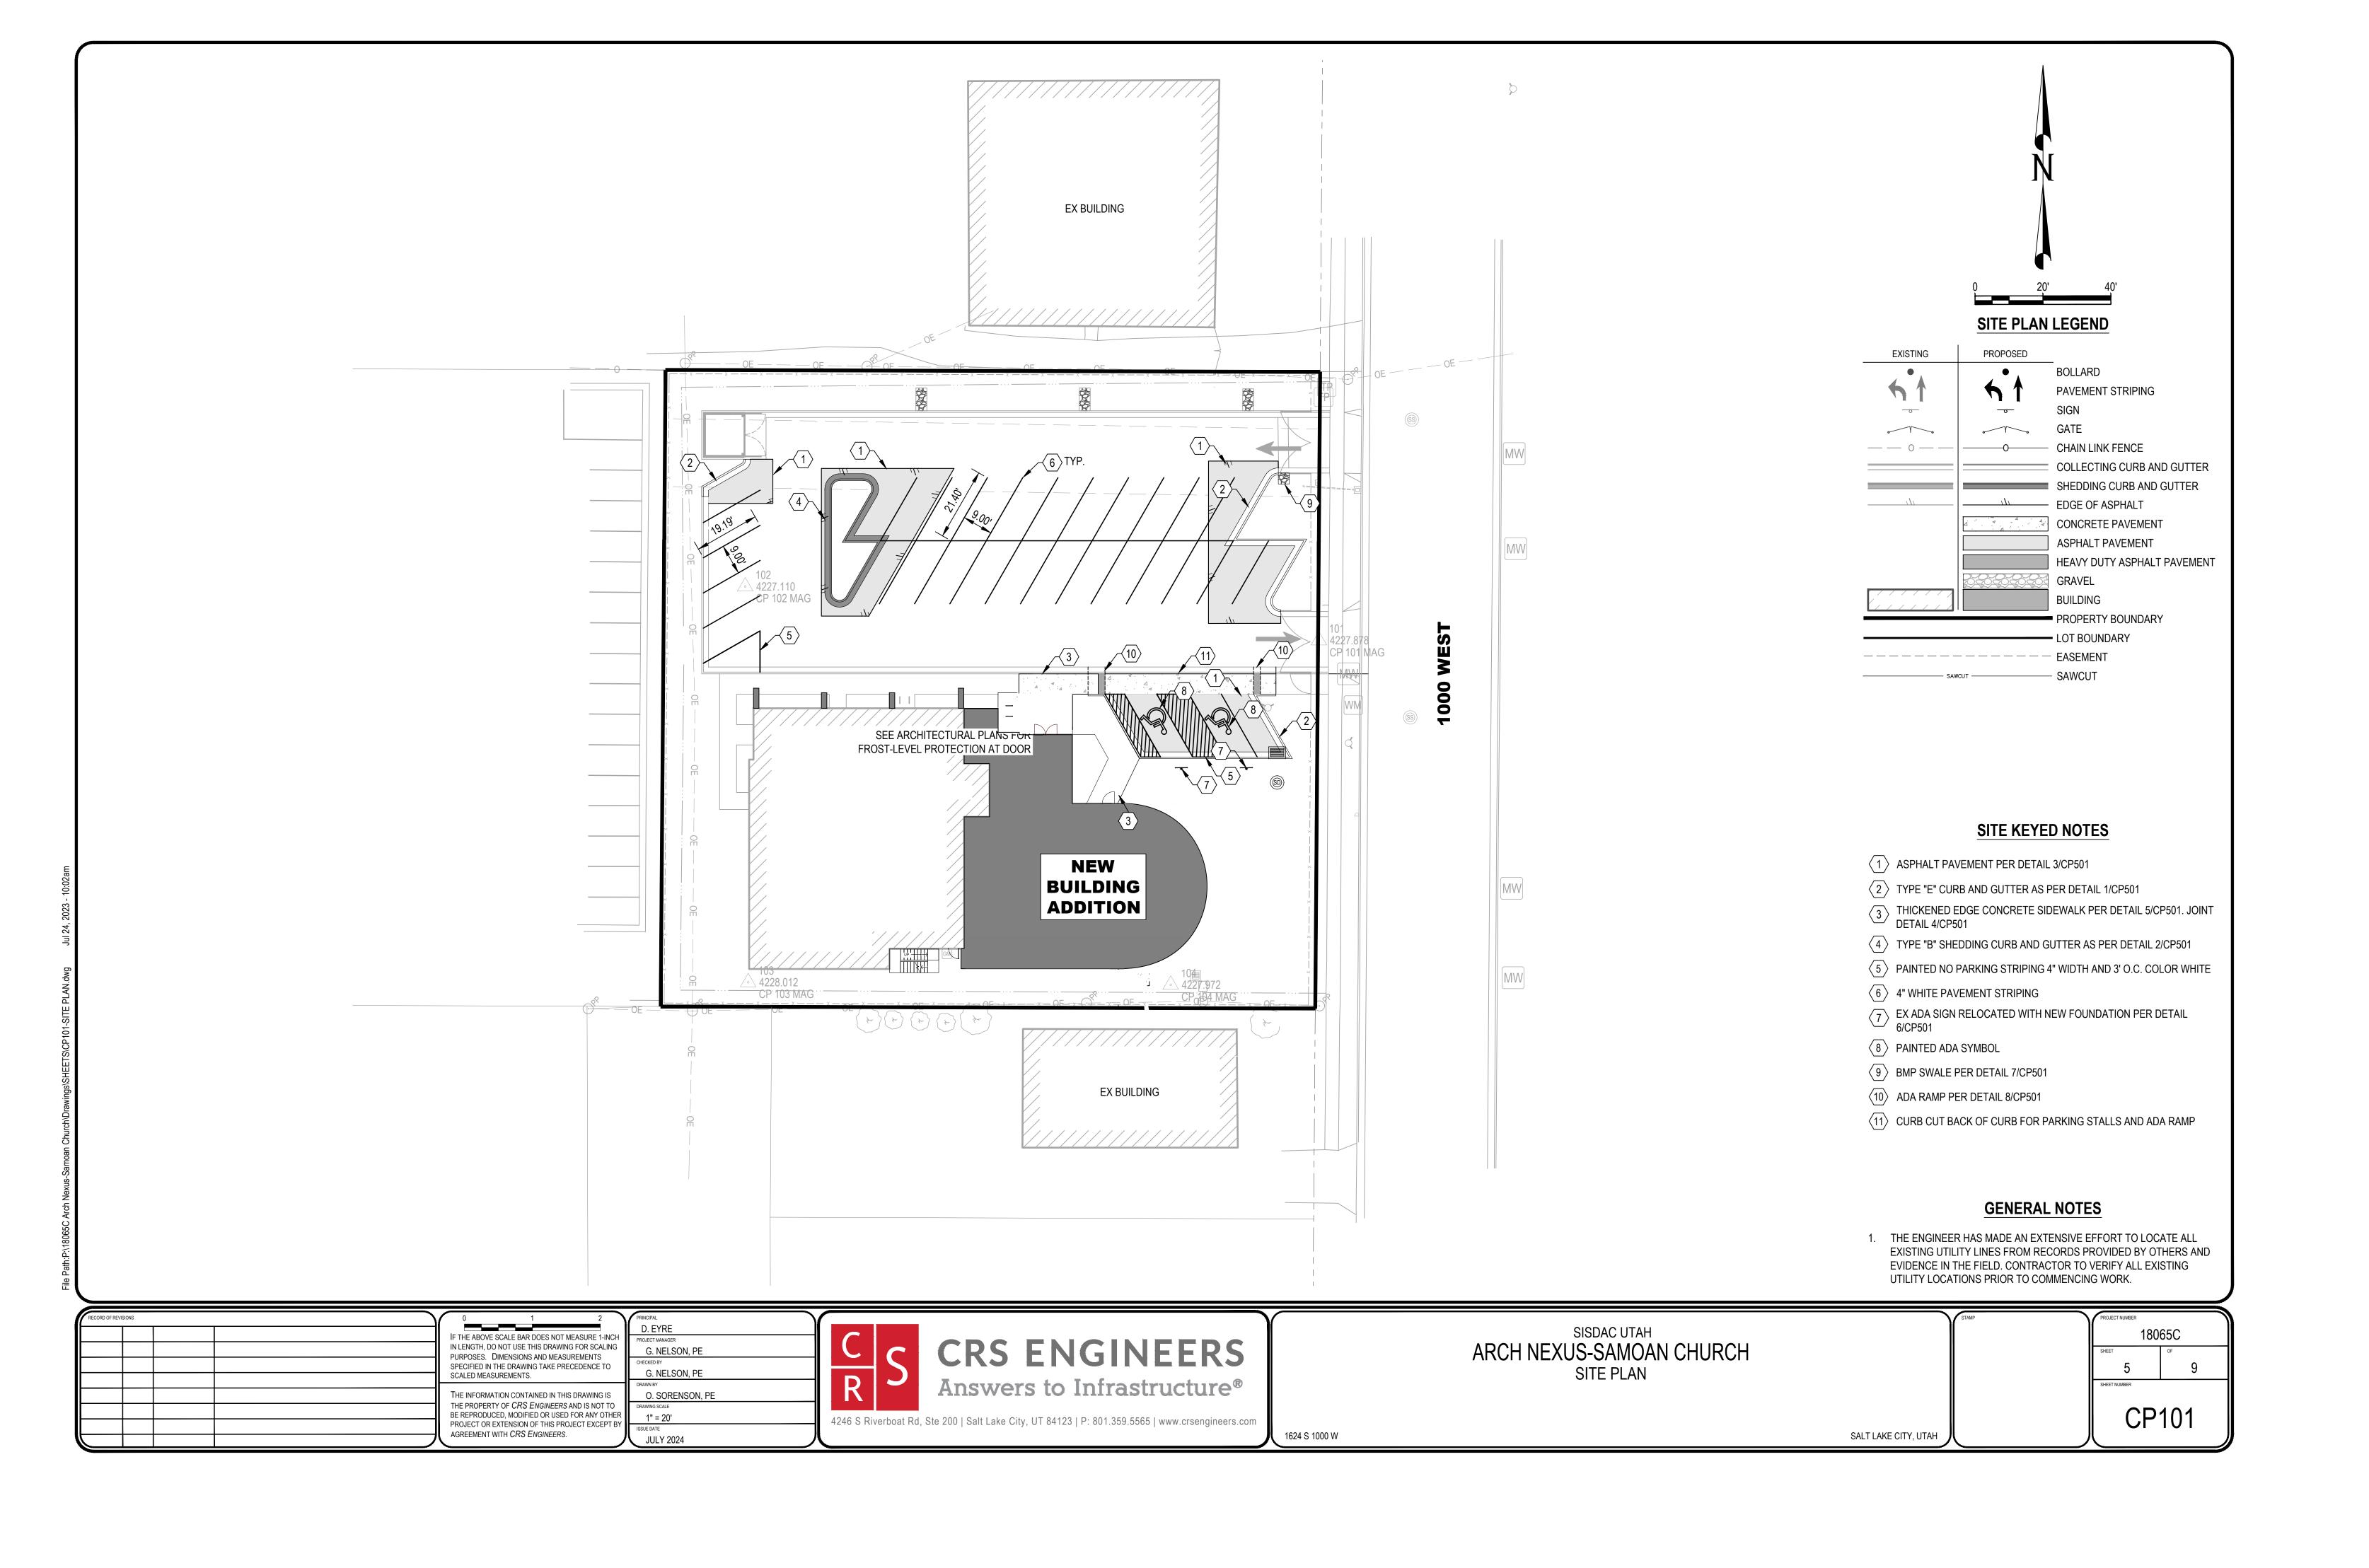

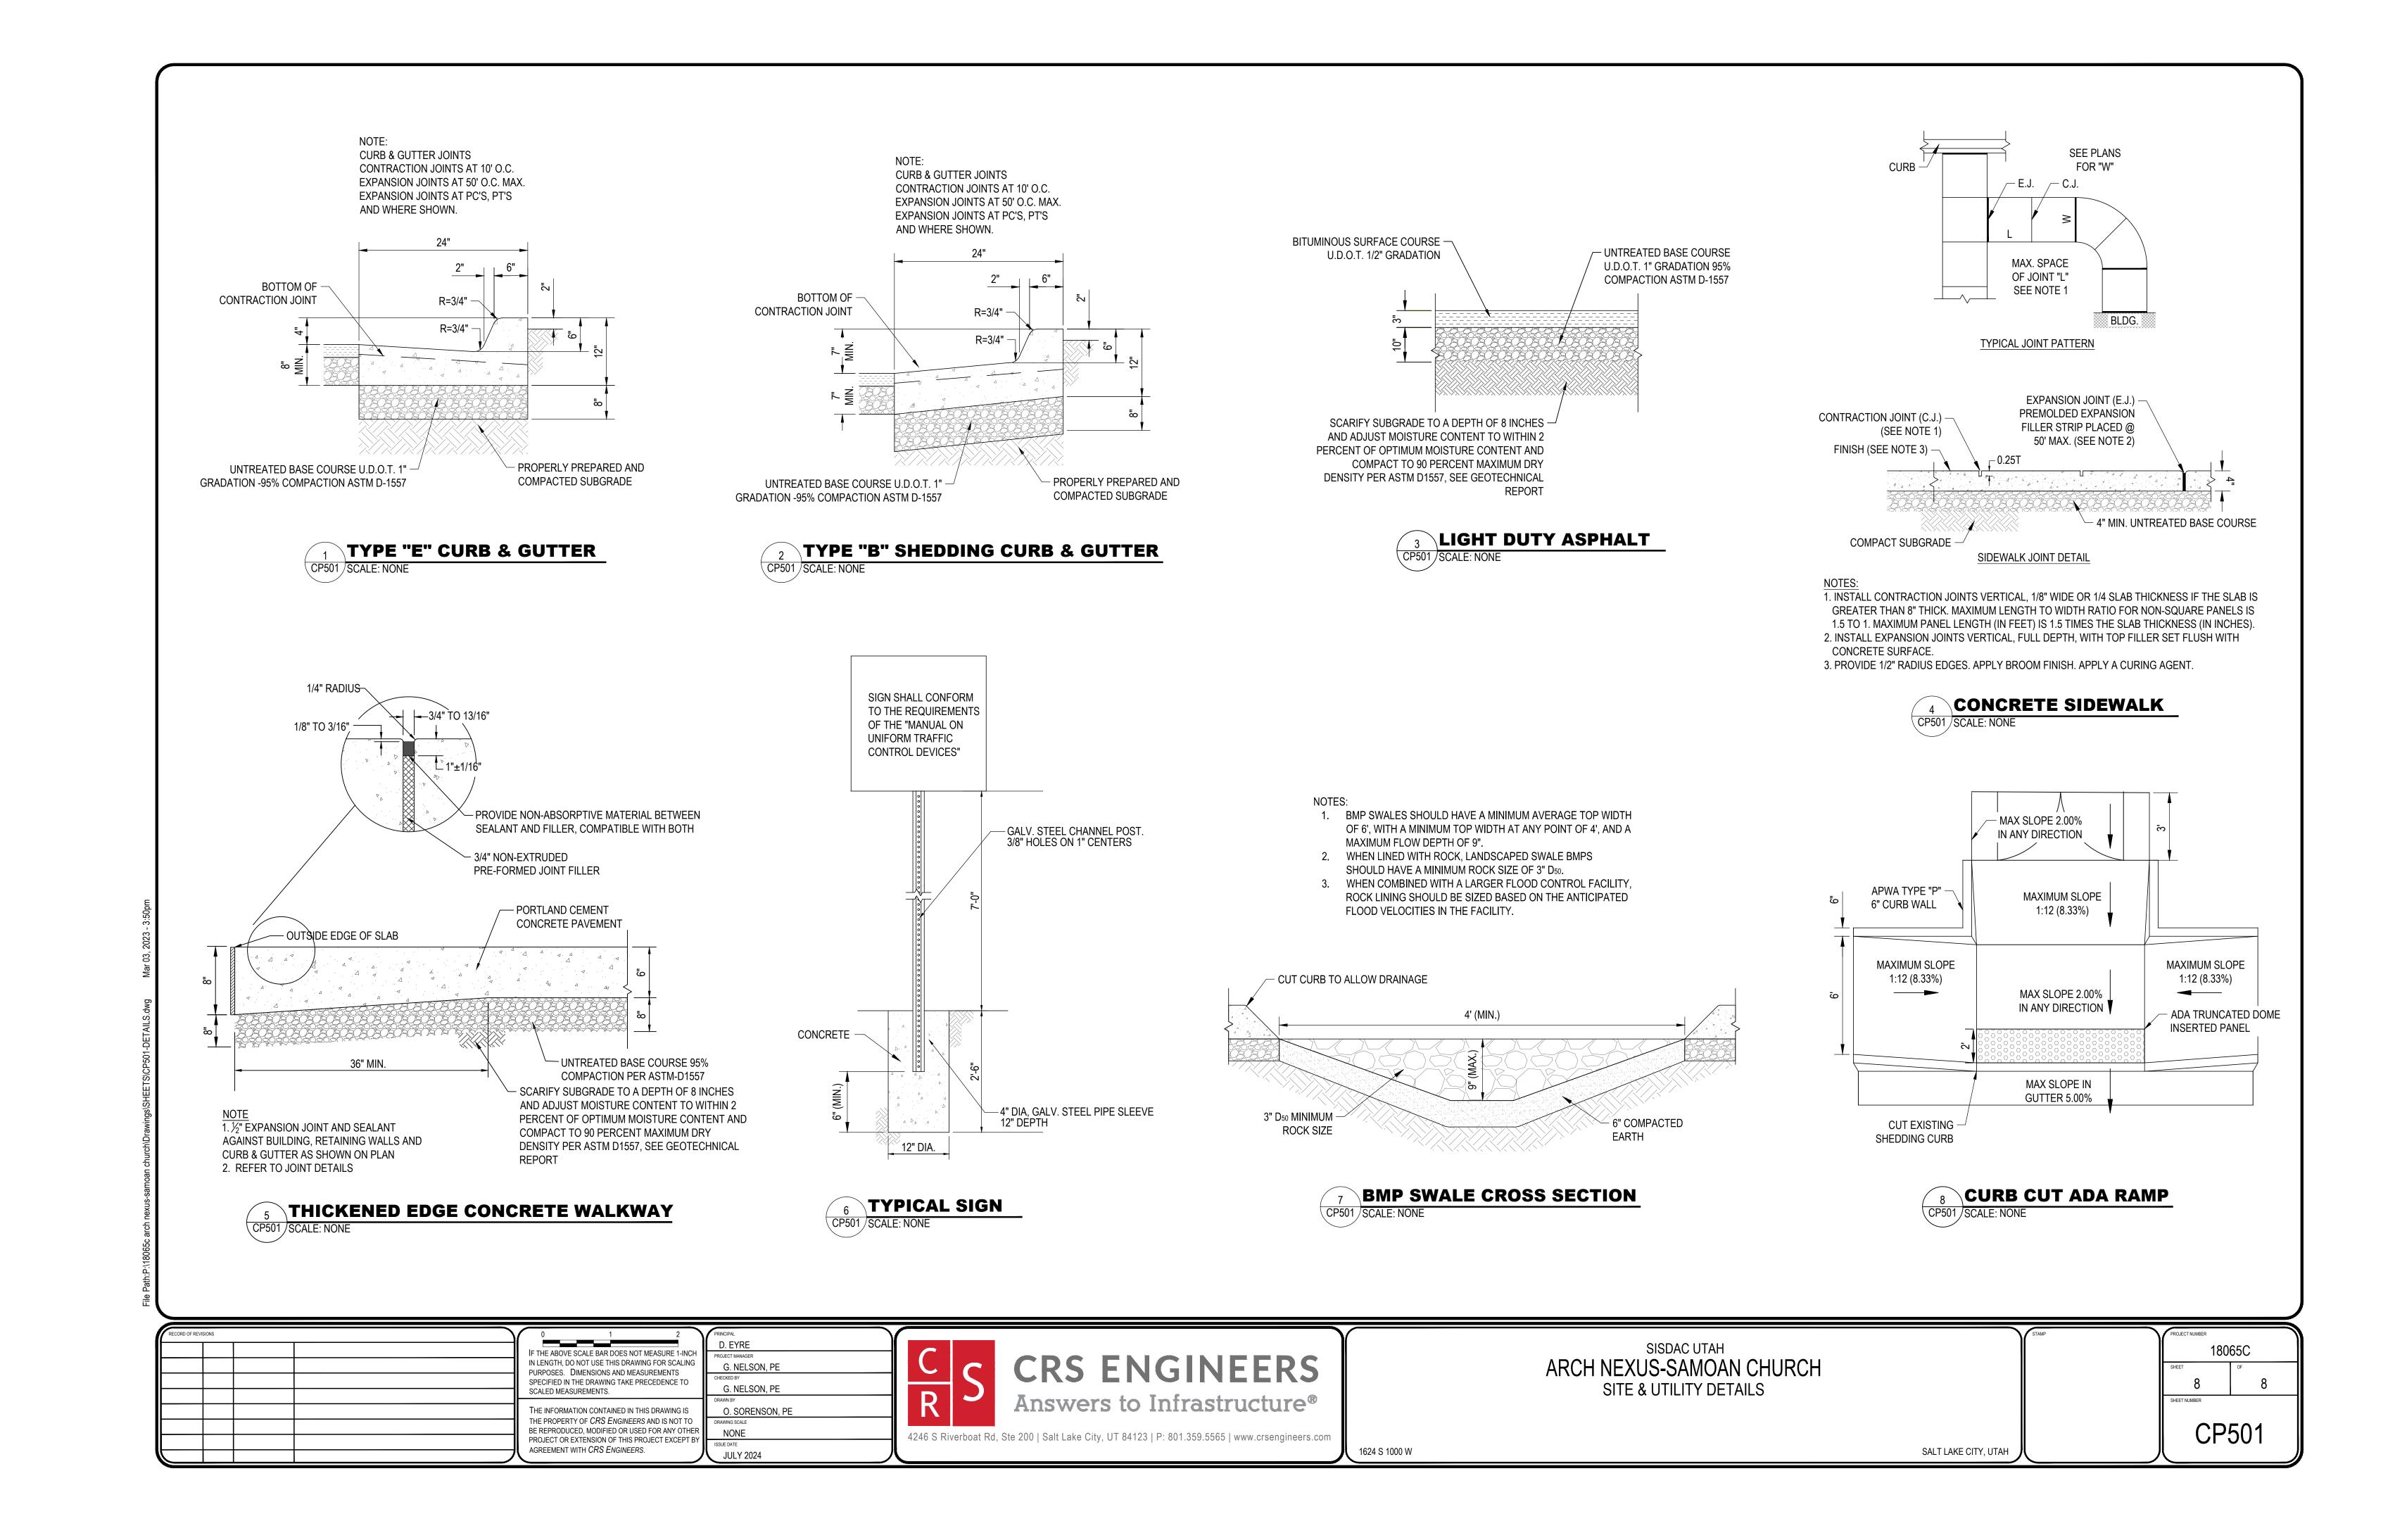

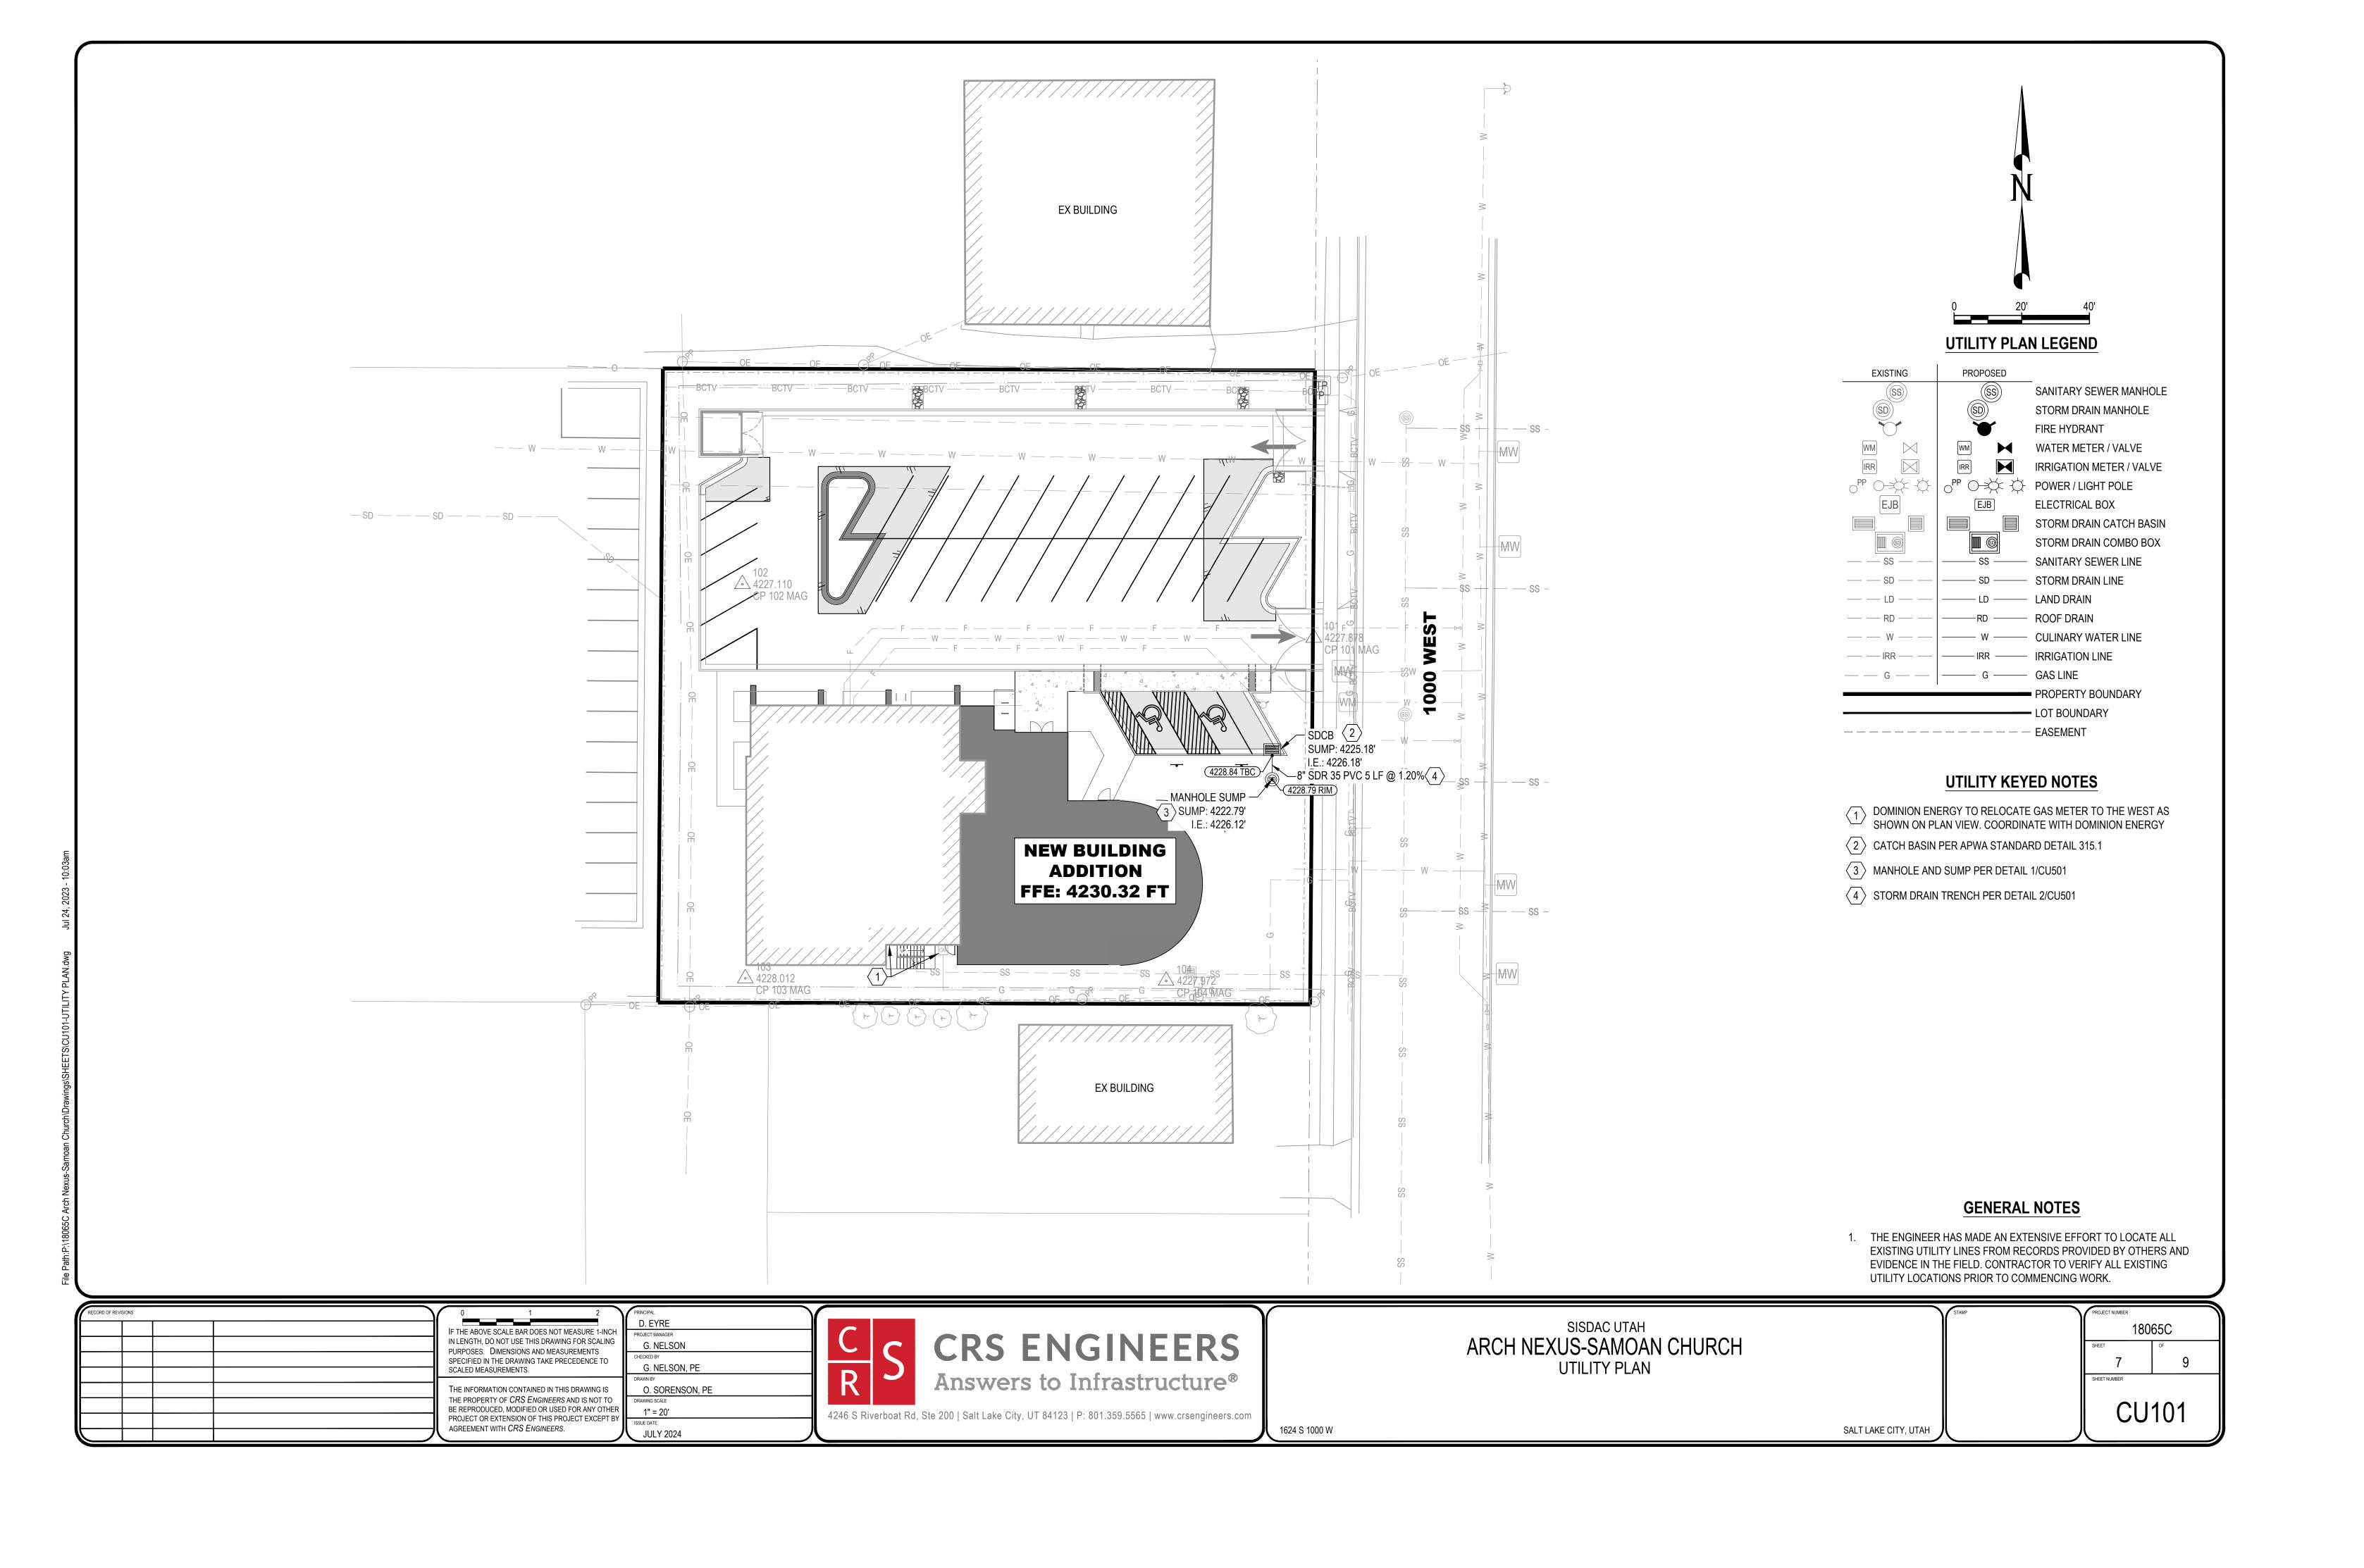



#### **SPRAY AREA NOTES:**

- CONTRACTOR SHALL ENSURE 100% HEAD TO HEAD COVERAGE BETWEEN SPRAY HEAD LOCATIONS IN ALL AREAS.
- 2. ADJUST SPRAY HEADS TO MINIMIZE OVERSPRAY ON TO HARDSCAPE, TYP. 3. ALL SPRAY BODIES SHALL BE
- PERPENDICULAR WITH GRADE, INCLUDING SLOPED AREAS. 4. SET PRESSURE REGULATING VALVES TO
- 40 PSI FOR SPRAY HEADS.
- 5. SEE PLANTING PLAN AND LEGEND FOR MORE INFORMATION.

#### IRRIGATION GENERAL NOTES:

- 1. THIS IRRIGATION SYSTEM HAS BEEN DESIGNED BASED ON A PEAK DEMAND OF 15 GPM AND A STATIC WATER PRESSURE READING AT P.O.C. AT 70 PSI.
- 2. THE CONTRACTOR IS RESPONSIBLE TO VERIFY THE STATIC WATER PRESSURE AT THE POINT OF CONNECTION AND TO BRING TO THE ATTENTION ANY DISCREPANCIES TO THE ARCHITECT OF STATED VERSUS ACTUAL STATIC WATER PRESSURE READINGS AT THE POINT OF CONNECTION ON CONTRACTOR COMPANY LETTERHEAD PRIOR TO BEGINNING WORK. IN THE EVENT THE CONTRACTOR FAILS TO VERIFY AND CONFIRM STATED VERSUS ACTUAL STATIC WATER PRESSURE PRIOR TO BEGINNING WORK AND DISCREPANCIES DO IN FACT EXIST, THE CONTRACTOR SHALL BE RESPONSIBLE FOR ANY AND ALL MODIFICATIONS TO THE IRRIGATION SYSTEM AT NO ADDITIONAL COST TO THE
- 3. THE IRRIGATION CONTROLLER IS LOCATED INSIDE THE RISER ROOM OF THE BUILDING. THE CONTRACTOR IS RESPONSIBLE FOR VERIFYING LOCATION AND CONNECTING THE CONTROLLER TO THE ELECTRICAL POINT OF CONNECTION. SHOULD THE CONTRACTOR FAIL TO CONNECT THE CONTROLLER TO THE ELECTRICAL POINT OF CONNECTION, THE CONTRACTOR SHALL BE RESPONSIBLE FOR ANY AND ALL MODIFICATIONS TO CONSTRUCTION WORK AS DIRECTED BY THE ARCHITECT INCLUDING AT NO ADDITIONAL COST TO THE OWNER.
- 4. ADDITIONALLY, THE CONTRACTOR IS RESPONSIBLE FOR CONNECTION OF WEATHER SENSING DEVICE AS INDICATED IN THE LEGEND AND FOR PROGRAMMING THE CONTROLLER TO FUNCTION WITH WEATHER SENSING INCLUDING BUT NOT LIMITED TO ALL PROGRAMMING AND WIRE CONNECTIONS AND ANY COMMUNICATION OR PAGING REQUIREMENTS FOR SETTING UP THE CONTROLLER SO THAT IT IS FULLY OPERABLE AT THE TIME OF SUBSTANTIAL COMPLETION.
- 5. POINT OF CONNECTION COMPONENTS SHALL BE CONNECTED TO THE AUTOMATIC CONTROLLER WITH DIRECT BURIAL, CONVENTIONAL WIRING. 6. ALL TURF GRASS AREAS SHALL BE IRRIGATED
- WITH POP-UP ROTARY AND SPRAY HEADS, WHICH SHALL PROVIDE 100% HEAD TO HEAD COVERAGE.
- POINT SOURCE DRIP IRRIGATION. 8. IRRIGATION ZONES ARE IDENTIFIED WITH THE
- FOLLOWING SYMBOL:

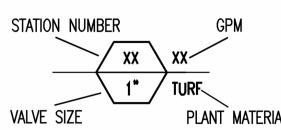

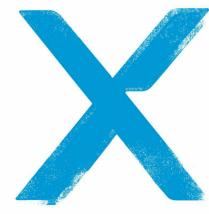

ARCH NEXUS

Architectural NEXUS, Inc. 2505 East Parleys Way Salt Lake City, UT 84109 T 801.924.5000

http://www.archnexus.com

Original drawings remain the property of the Architect and as such the Architect retains total ownership and control. The design represented by these drawings is sold to the client for a one time use, unless otherwise agreed upon in writing by the Architect.

© Architectural Nexus, Inc. 2017


**Z** >

Ш

DA

7. ALL PLANTER AREAS SHALL BE IRRIGATED WITH

Date

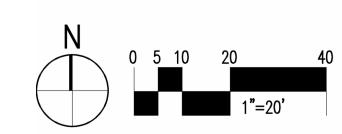

#### CONDITIONAL **USE PERMIT**

NEXUS PROJECT #:21021.01 CHECKED BY: DRAWN BY: 07.19.24 DATE:

**IRRIGATION PLAN** 

IRRIGATION SCHEDULE

SYMBOL	MANUFACTURER/MODEL/DESCRIPTION	<u>QTY</u>	<u>PSI</u>	<u>DETAIL</u>
$\langle \overline{A} \rangle$	Hunter MP2000 PROS-06-PRS40-CV Turf Rotator, 6" pop-up with check valve, pressure regulated to 30 psi, MP Rotator nozzle on PRS40 body. M=Maroon adj arc 90 to 210, L=Light Blue 210 to 270 arc, O=Olive 360 arc.	7	40	C1 L1702
B	Hunter MP3000 PROS-06-PRS40-CV 6" pop-up with factory installed check valve, pressure regulated to 30 psi, MP Rotator nozzle on PRS40 body. K=Black adj arc 90-210, G=Green adj arc 210-270, R=Red 360 arc.	6	40	C1 LI702
SYMBOL	MANUFACTURER/MODEL/DESCRIPTION	<u>QTY</u>		C1 LI702 <u>DETAIL</u>
Φ	Rain Bird MDCFCAP Dripline Flush Valve cap in compression fitting coupler.	3		
	Area to Receive Drip Emitters Rain Bird XB-PC Single Outlet, Pressure Compensating Drip Emitters. Flow rates of 0.5gph=blue, 1.0gph=black, and 2.0gph=red. Comes with a self-piercing barb inlet x barb outlet.			A2, A4, C2, C4 LI703
	Emitter Notes:  0.5 GPH emitters (1 assigned to each 1 gal. plant)  1.0 GPH emitters (6 assigned to each 2" Cal. plant)  1.0 GPH emitters (6 assigned to each 25 gal. plant)  1.0 GPH emitters (2 assigned to each 3 gal. plant)  1.0 GPH emitters (2 assigned to each 5 gal. plant)  1.0 GPH emitters (6 assigned to each tree)			A2, A4, C2, C4 LI703
SYMBOL	MANUFACTURER/MODEL/DESCRIPTION	<u>QTY</u>		<u>DETAIL</u>
•	DRIP VALVE - Rain Bird PESB-PRS-D 1" 1" Plastic Industrial Valves. Low Flow Operating Capability, Globe Configuration. With Pressure Regulating Module, and Scrubber Technology	1		
<b>99</b>	(E) TURF /DRIP VALVES - Rain Bird PESB 1"/PESB-PRS-D1"	14		A2 LI702
	(E) Hunter HQ-44LRC 1"  Quick coupler valve, yellow rubber locking cover, red brass and stainless steel, with 1" NPT inlet, 2-piece body.	4		C2 LI702
	(E) Nibco T-FP-600A Brass ball valve shut off valve	1		
С	(E) Hunter IC-1800-PL Modular Controller, 18 stations, Outdoor Model, Plastic Cabinet. Commercial Use. With two ICM-600 modules included.	1		A4 LI701
<b>SS</b> >	(E) Hunter WSS	1		A4 LI701
	Wireless Solar, rain freeze sensor with outdoor interface, connects to Hunter PCC, Pro-C, and I-Core Controllers, install as noted. Includes 10 year lithium battery and rubber module cover, and gutter mount bracket.			A2 LI701
	<ul> <li>Irrigation Lateral Line: PVC Schedule, size per plan.</li> </ul>			C3 LI701
	Pipe Sleeve: PVC Schedule 40. 2 X size of pipe.			



Architectural NEXUS, Inc. 2505 East Parleys Way Salt Lake City, UT 84109 T 801.924.5000 http://www.archnexus.com

Original drawings remain the property of the Architect and as such the Architect retains total ownership and control. The design represented by these drawings is sold to the client for a one time use, unless otherwise agreed upon in writing by the Architect.

© Architectural Nexus, Inc. 2017

# SAMOAN INDEPENDENT ADVE

# Date Revision

CONDITIONAL USE PERMIT

NEXUS PROJECT #:21021.01 CHECKED BY: JG DRAWN BY: JS DATE: 02.27.23

IRRIGATION LEGEND

L1601



Architectural NEXUS, Inc. 2505 East Parleys Way Salt Lake City, UT 84109 T 801.924.5000

http://www.archnexus.com

Original drawings remain the property of the Architect and as such the Architect retains total ownership and control. The design represented by these drawings is sold to the client for a one time use, unless otherwise agreed upon in writing by the Architect.

© Architectural Nexus, Inc. 2017

PENDENT ADVE SAMOAN

INDEF

Date

CONDITIONAL **USE PERMIT** 

NEXUS PROJECT #:21021.01 CHECKED BY: JG DRAWN BY: JS 02.27.23 DATE:

**IRRIGATION DETAILS** 

**LI701** 



Architectural NEXUS, Inc. 2505 East Parleys Way Salt Lake City, UT 84109 T 801.924.5000

http://www.archnexus.com

Original drawings remain the property of the Architect and as such the Architect retains total ownership and control. The design represented by these drawings is sold to the client for a one time use, unless otherwise agreed upon in writing by the Architect.

© Architectural Nexus, Inc. 2017

PENDENT ADVE

INDEF

SAMOAN


Date Revision

CONDITIONAL **USE PERMIT** 

NEXUS PROJECT #21021.01 CHECKED BY: DRAWN BY: 02.14.20 DATE:

**IRRIGATION DETAILS** 

**LI702** 

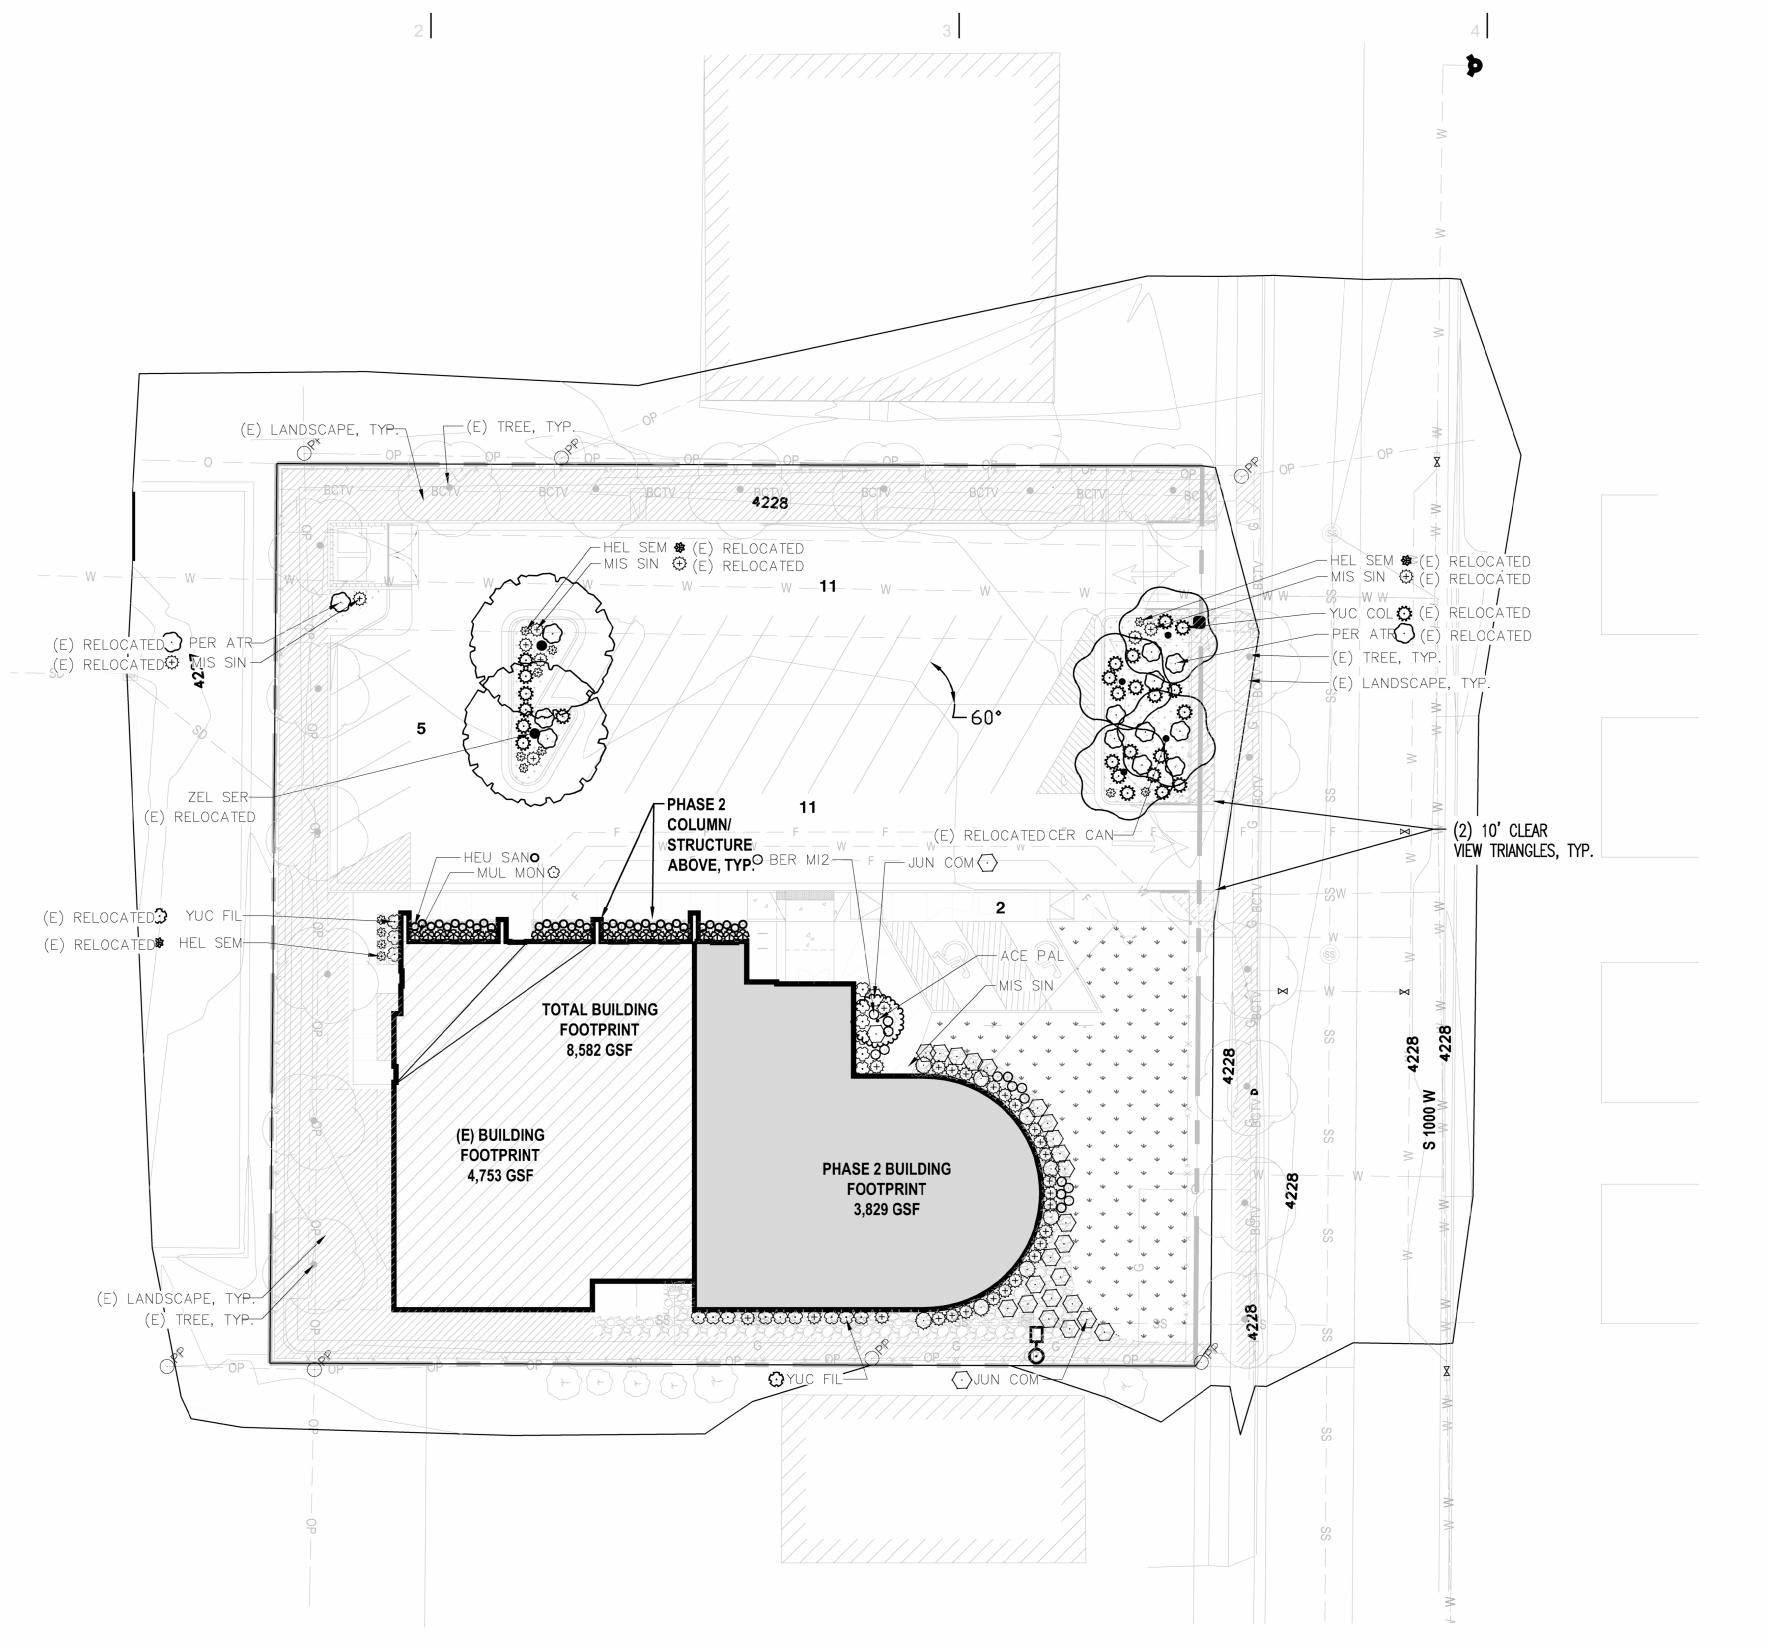

SEE PLANTING LEGEND AND **DETAILS SHEETS** LP601/701

#### PLANTING PLAN GENERAL NOTES:

1. THE CONTRACTOR IS RESPONSIBLE FOR COMPARING THE EXISTING SITE CONDITIONS WITH THE PLANTING PLAN PRIOR TO BEGINNING WORK AND IMMEDIATELY NOTIFYING THE ARCHITECT IN WRITING OF ANY DISCREPANCIES BETWEEN ACTUAL SITE CONDITIONS AND THE PLANTING PLAN. IN THE EVENT THE CONTRACTOR FAILS TO COMPARE EXISTING SITE CONDITIONS WITH THE PLANTING PLANS PRIOR TO BEGINNING WORK AND/OR FAILS TO NOTIFY THE ARCHITECT OF ANY DISCREPANCIES IN WRITING PRIOR TO BEGINNING WORK, THE CONTRACTOR SHALL ASSUME FULL RESPONSIBILITY FOR ANY REQUIRED ALTERATIONS AND ADDITIONS TO THE PLANTING PLAN, INCLUDING ADDITIONAL MATERIALS AT NO ADDITIONAL COST TO THE OWNER.

2. CONTRACTOR SHALL COORDINATE PLANT PLACEMENT WITH IRRIGATION SYSTEM.

3. CONTRACTOR SHALL IMMEDIATELY REPAIR ANY DAMAGES CAUSED BY CONSTRUCTION OPERATIONS, ON OR OFF OF THE SITE, WITH NO ADDITIONAL COSTS TO THE OWNER.

4. REFER TO PLANTING LEGEND, DETAILS AND SPECIFICATIONS FOR MORE INFORMATION.

ARCH | NEXUS

2505 East Parleys Way Salt Lake City, UT 84109 T 801.924.5000 http://www.archnexus.com

Architectural NEXUS, Inc.

Original drawings remain the property of the Architect and as such the Architect retains total ownership and control. The design represented by these drawings is sold to the client for a one time use, unless otherwise agreed upon in writing by the Architect.

© Architectural Nexus, Inc. 2017

#### **MATERIALS**:

#### <u>SYMBOL</u>



CALICO COBBLE ROCK MULCH STAKER PARSONS, 1"-2" IN SIZE, MULTI-COLORED DECORATIVE ROCK (LOCATED @ BUILDING APRON)



COLOR: BLACK

EXISTING LANDSCAPE, RETAIN AND PROTECT IN PLACE.

#### **DESCRIPTION**




BARK MULCH, STAKER PARSONS,



WEED BARRIER FABRIC, DeWITT, 6'x250',COLOR: BLACK, 5 oz. WOVEN, NEEDLE—PUNCHED POLYPROPYLENE FABRIC, APPLICATION FOR PLANTING BEDS WITH CALICO COBBLE



DEN

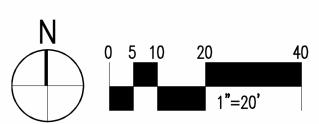

## CONDITIONAL USE PERMIT

NEXUS PROJECT #:21021.01 CHECKED BY: DRAWN BY: DATE: 07.18.24

**PLANTING PLAN** 

**LP101** 

PLANTING SCHEDULE

FLANTING	SOLIED	OLL				
TREES	CODE	BOTANICAL NAME	COMMON NAME	CONTAINER SIZE	MATURE SIZE (HXW)	QTY
Example (	ACE PAL	SHISHIGASHIRA JAPANESE MAPLE	ACER PALMATUM 'SHISHIGASHIRA'	5'-6'	12 <b>`</b> X10 <b>`</b>	1
	CER CAN	CERCIS CANADENSIS	EASTERN REDBUD	2" CAL.	20'X20'	3 (E)
	ZEL SER	ZELKOVA SERRATA 'GREEN VASE'	GREEN VASE ZELKOVA	2" CAL.	50'X40'	2 (E)
<u>SHRUBS</u>	CODE	BOTANICAL NAME	COMMON NAME	CONTAINER SIZE	MATURE SIZE (HXW)	<u>QTY</u>
$\odot$	BER MI2	BERBERIS THUNBERGII 'MIMI' TM	SUNJOY MINI SALSA BARBERRY	#2	2'X2'	21
⊙	HEU SAN	HEUCHERA SANGUINEA	CORAL BELLS	1 GAL.	1'X15"	41
$\langle \cdot \rangle$	JUN CON	JUNIPERUS CONFERTA 'BLUE PACIFIC'	BLUE PACIFIC SHORE JUNIPER	<b>#</b> 5	1'X4'	34
&	MUL MON	MUHLENBERIA MONTANA	MOUNTAIN MUHLY	<b>#</b> 5	2.5 <b>`</b> X2 <b>`</b>	27
$\odot$	PER ATR	PEROVSKIA ATRIPLICIFOLIA	RUSSIAN SAGE	<b>#</b> 5	4'X4'	(E)
0	THU SMA	THUJA OCCIDENTALIS 'SMARAGD'	EMERALD GREEN ARBORVITAE	#15	15 <b>`</b> X4 <b>`</b>	9
<u>GRASSES</u>	<u>CODE</u>	BOTANICAL NAME	COMMON NAME	CONTAINER SIZE	MATURE SIZE (HXW)	QTY
₩	HEL SEM	HELICTOTRICHON SEMPERVIRENS 'BLUE OATS'	BLUE OAT GRASS	1 GAL.	36"X24"	(E)
<b>⇔</b>	MIS SIN	MISCANTHUS SINENSIS 'ADAGIO'	ADAGIO MAIDEN GRASS	#1	3'X3'	33/(E)
<u>PERENNIALS</u>	<u>CODE</u>	BOTANICAL NAME	COMMON NAME	CONTAINER SIZE	MATURE SIZE (HXW)	<u>QTY</u>
<b>③</b>	YUC FIL	YUCCA FILAMENTOSA	ADAM'S NEEDLE	3 GAL.	3'X3'	12/(E)
₹ <b>*</b> }	YUC COL	YUCCA FILAMENTOSA 'COLOR GUARD'	ADAM'S NEEDLE	3 GAL.	3'X3'	(E)
SOD/SEED	<u>CODE</u>	BOTANICAL NAME	COMMON NAME	CONTAINER SIZE	MATURE SIZE (HXW)	<u>QTY</u>
,	POA PRA	SOD BIONATIVE FROM BIOGRASS, OR EQUAL	BLUEGRASS	SOD		2,290 S



Architectural NEXUS, Inc. 2505 East Parleys Way Salt Lake City, UT 84109 T 801.924.5000

http://www.archnexus.com Original drawings remain the property of the Architect and as such the Architect retains total ownership and control. The design represented by these drawings is sold to the client for a one time use, unless otherwise agreed upon in writing by the Architect.

© Architectural Nexus, Inc. 2017

# Date Revision

CONDITIONAL USE PERMIT NEXUS PROJECT #:21021.01 CHECKED BY: JG DRAWN BY: JS DATE: 02.27.23

**PLANTING** 

**LEGEND** 

**LP601** 



Architectural NEXUS, Inc. 2505 East Parleys Way Salt Lake City, UT 84109 T 801.924.5000

http://www.archnexus.com

Original drawings remain the property of the Architect and as such the Architect retains total ownership and control. The design represented by these drawings is sold to the client for a one time use, unless otherwise agreed upon in writing by the

Architect. © Architectural Nexus, Inc. 2017

PENDENT ADVE INDEF SAMOAN

# Date

CONDITIONAL **USE PERMIT** 


NEXUS PROJECT #:21021.01 CHECKED BY: DRAWN BY: 02.27.23 DATE:


JG JS


LANDSCAPE


**DETAILS** 




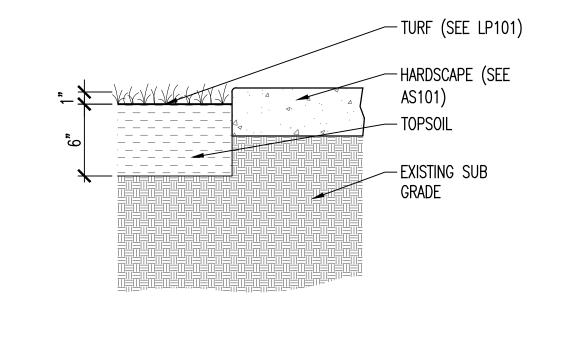

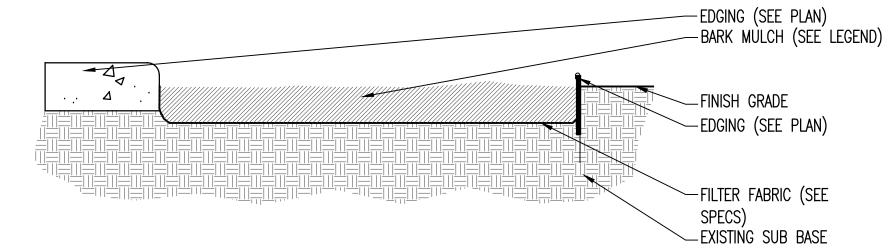

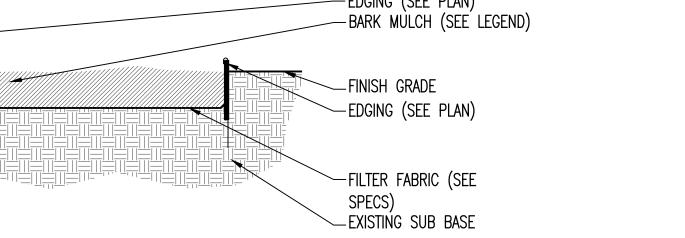


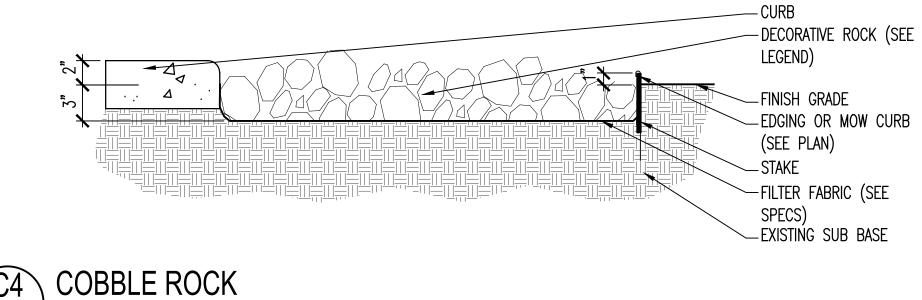


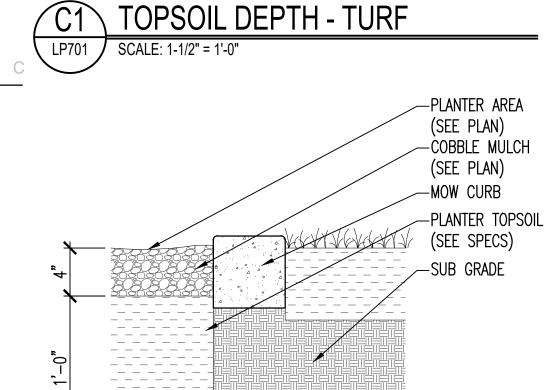



TOPSOIL DEPTH - PLANTER

LP701 SCALE: 1-1/2" = 1'-0"

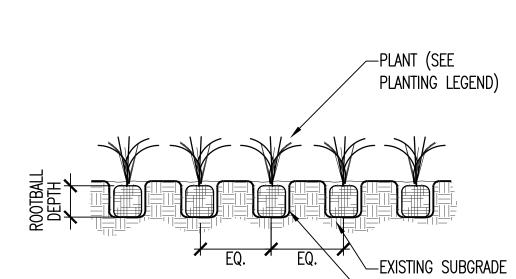


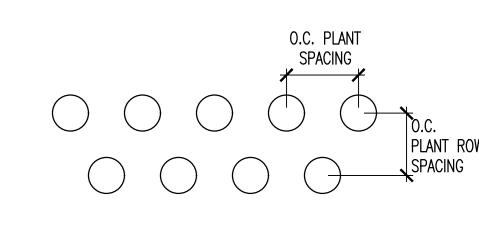


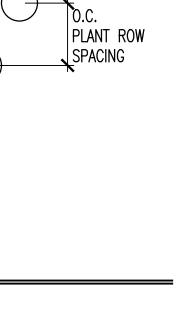

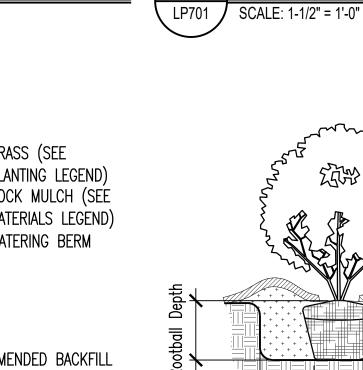

-AMENDED BACKFILL

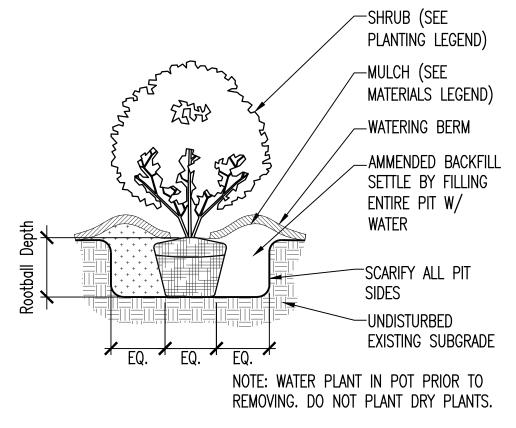

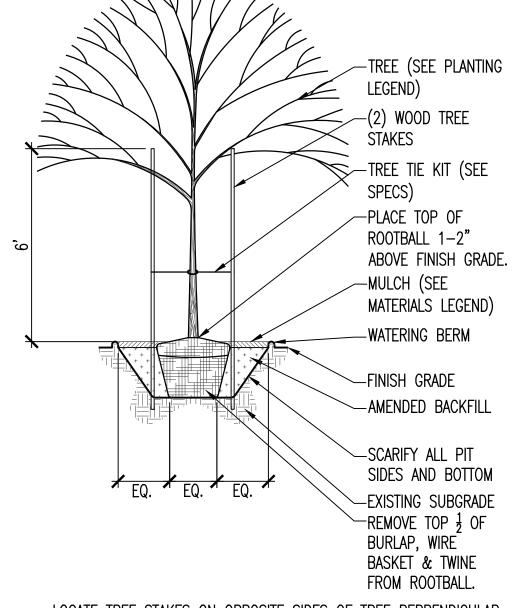

LOCATE TREE STAKES ON OPPOSITE SIDES OF TREE PERPENDICULAR TO PREVAILING WIND.

ORNAMENTAL GRASSES SCALE: 1" = 1'-0"

SHRUB ON GRADE LP701 SCALE: 1/2" = 1'-0"

B3 PLANT SPACING

TREE WITH STAKING LP701 SCALE: 1/4" = 1'-0"

SCALE: 1 1/2" = 1'-0"

B2 PLANT SPACING LP701 SCALE: 1-1/2" = 1'-0"

C2 BARK MULCH

SCALE: 1 1/2" = 1'-0"

-GRASS (SEE PLANTING LEGEND)
-ROCK MULCH (SEE MATERIALS LEGEND) -WATERING BERM -AMENDED BACKFILL EXISTING SUBGRADE


#### **KEY NOTES DESCRIPTION** SI-101 ASPHALT PAVING, SEE CIVIL DWGS SI-102 ASPHALT STRIPING, SEE CIVIL DWGS SI-103 4" CONCRETE PAVING, SEE CIVIL DWGS SI-104 SAW CUT CONTROL JOINT SI-105 CONCRETE CURB AND GUTTER, SEE CIVIL DWGS SI-106 ADA SIGN, SEE CIVIL DWGS SI-107 THE RAMBLER WIDE BIKE RACK, TYP. OF 2. SI-108 ALUMINUM LANDSCAPE EDGING SI-109 NOT USED

#### LEGEND:

SI-110


SI-111

SI-112

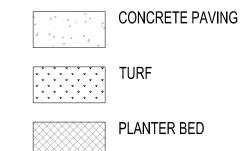

ADA RAMP, SEE CIVIL

**EXPANSION JOINT** 

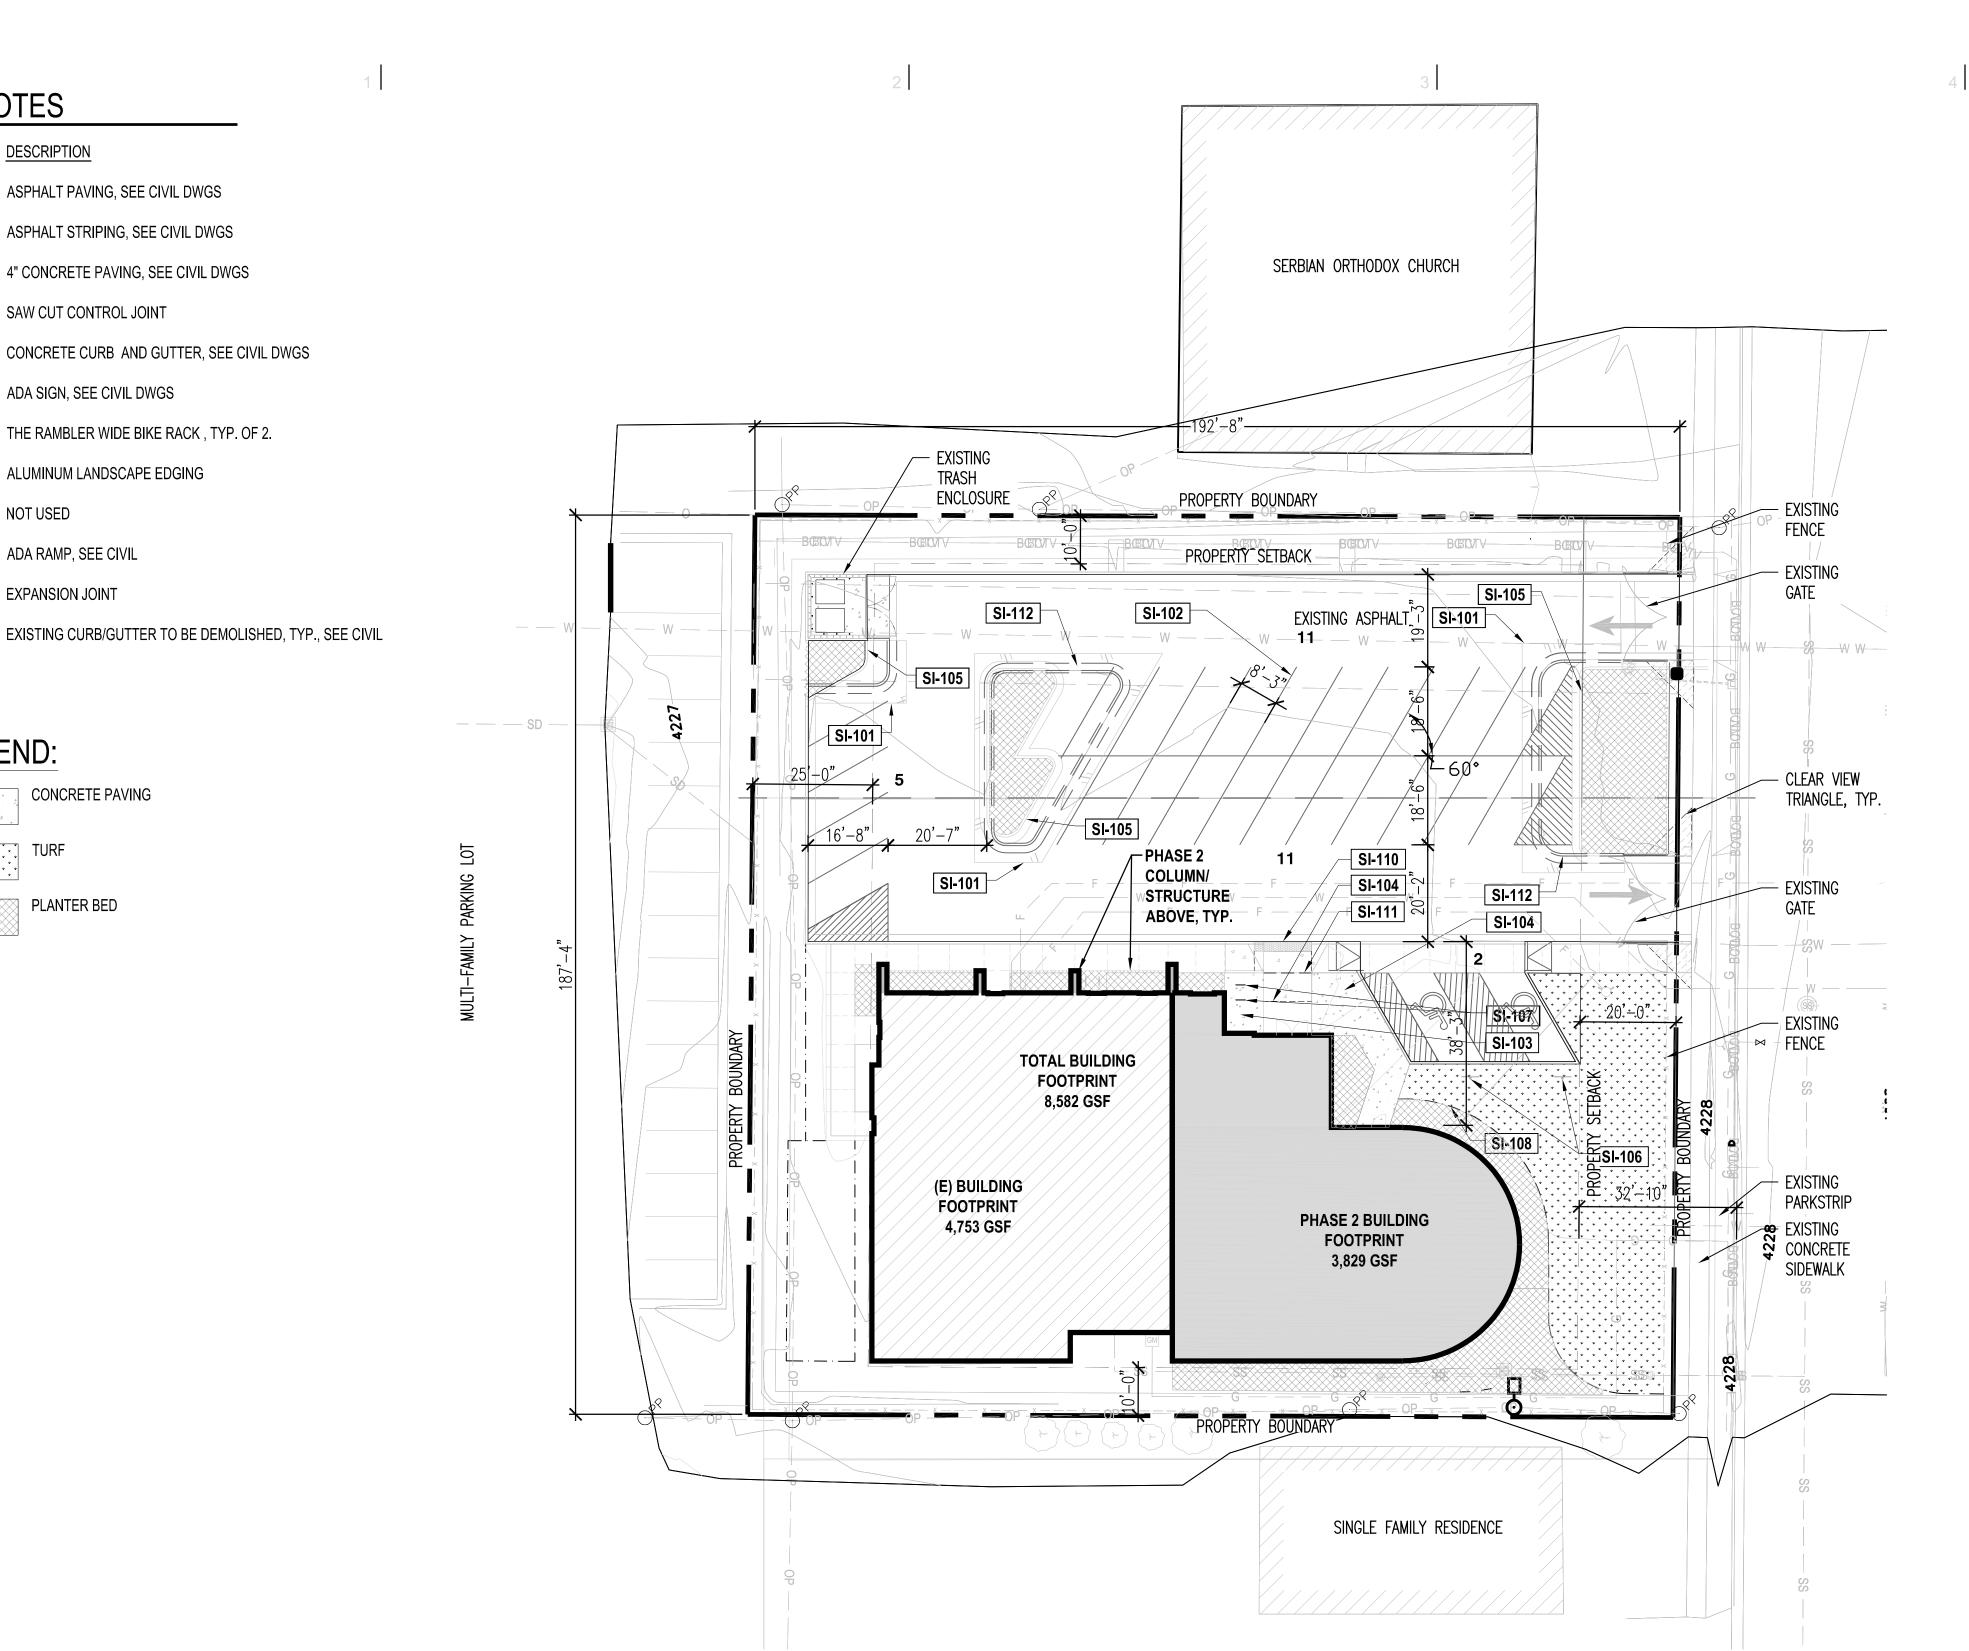

#### SITE COVERAGE:

 TOTAL SITE AREA: 36,128 sf (100.0%) BUILDING FOOTPRINT: 8,582 sf (24%)

#### **PARKING DATA:**

REQUIRED PARKING CALCULATIONS

 ROOMING HOUSE (1 unit) PLACES OF WORSHIP (1 stall/300 SF @ 3,174 sf)

• ALL OTHER USES (3 stall/1,000 sf @ 6,996) TOTAL MINIMUM REQUIRED STALLS

• REQUIRED ADA STALLS (1 ada / 25 stalls):

TREGUINED NON OTNEED (Tada / 20 Stalls)	·•
PROPOSED PARKING	
• EXISTING STALLS (2 ADA)	20
NEW STANDARD STALLS	9
<ul> <li>NEW ADA STALLS</li> </ul>	0
TOTAL PROVIDED PARKING	29
INTERIOR PARKING LOT LANDSCAPE	
<ul> <li>TOTAL PARKING LOT AREA:</li> </ul>	13,524 sf
<ul> <li>LANDSCAPE AREA REQUIRED (5%):</li> </ul>	727 sf
<ul> <li>LANDSCAPE AREA PROVIDED:</li> </ul>	750 sf
<ul> <li>REQUIRED TREES (1/120 sf):</li> </ul>	6
<ul><li>PROVIDED TREES:</li></ul>	6
PARKING LOT PERIMETER PLANTING	
<ul> <li>NORTH PERIMETER (EXISTING):</li> </ul>	184.5 lf
	_

NORTH PERIMETER (EXISTING). • TREES REQUIRED (1/30 ft): TREES PROVIDED: • SHRUBS REQUIRED (1/3 ft -100%):

 WEST PERIMETER (EXISTING): TREES REQUIRED (1/30 ft): TREES PROVIDED: SHRUBS REQUIRED (1/3 ft -100%):

REQUIRED BIKE PARKING

SHRUBS PROVIDED:

SHRUBS PROVIDED:

• 5% OF PROVIDED VEHICULAR PARKING (29) = 1.45 TOTAL PROVIDED BIKE PARKING

76.5 lf

#### **GENERAL NOTES:**

A. TAX PARCEL #15-14-252-013-0000. LEGAL DESCRIPTION: BEG E 12 RDS & N 455.395 FT FR SW COR OF NE 1/4 SEC 14, T 1S, R 1W, SLM; N 0^11'15" E 50 FT; S 89^55'53" W 192.78 FT; S 0^11'15" W 50 FT; N 89<sup>55</sup>'53" E 192.78 FT TO BEG. 0.22 AC 7100-749 9321-542 9875-6308

B. TAX PARCEL #15-14-252-014-0000. LEGAL DESCRIPTION: BEG E 198 FT & N 317.695 FT FR CEN SEC 14, T 1S, R 1W, S L MN 0^11"15" E 137.7 FT; S 89^55"53" W 192.78 FT; S 0^11'15" W137.7 FT M OR L; N

89^55"53" E 192.78 FT TO BEG. 0.61 AC M OR L 4917-0787 6469-1281 6592-1987 7100-0751 7452-2348 8595-6349 9875-6308

C. OFF-STREET PARKING IS TO COMPLY WITH SALT LAKE CITY ORDINANCE (21A.44.020) AND RELATED SECTIONS. D. LANDSCAPE REQUIREMENTS INCLUDING, BUT NOT

LIMITED TO, LANDSCAPE BUFFERS ARE TO COMPLY WITH SALT LAKE CITY ORDINANCE (21A.48) AND RELATED SECTIONS.

E. FIELD VERIFY ALL EXISTING CONDITIONS AND THEIR COMPATIBILITY WITH NEW CONSTRUCTION PRIOR TO THE COMMENCEMENT OF WORK. COORDINATE DISCREPANCIES WITH ARCHITECT. F. DO NOT SCALE DRAWINGS.

G. PROVIDE ADA PARKING SIGN AT EACH DESIGNATED ADA PARKING STALL.

H. COORDINATE ALL UTILITY CROSSING INCLUDING; STORM DRAINS, WATER, AND GAS LINES. COORDINATE DEMO WORK AND SCHEDULING WITH CIVIL AND LANDSCAPING. PROVIDE BLOCK OUTS FOR UTILITY TO PASS THRU FOUNDATION WALLS. SEE TYPICAL DETAILS IN CIVIL, LANDSCAPE AND STRUCTURAL.

I. THE CONTRACTOR IS RESPONSIBLE TO VERIFY THE EXISTING SITE CONDITIONS AND THEIR COMPATIBILITY WITH NEW CONSTRUCTION PRIOR TO BEGINNING WORK AND TO BRING TO THE ATTENTION OF THE ARCHITECT ANY DISCREPANCIES OF STATED VERSUS ACTUAL SITE CONDITIONS. SHOULD DISCREPANCIES EXIST THE CONTRACTOR IS RESPONSIBLE FOR PROVIDING WRITTEN NOTICE OF SUCH DISCREPANCIES DELIVERED TO THE ARCHITECT ON CONTRACTOR COMPANY LETTERHEAD PRIOR TO BEGINNING WORK. IN THE EVENT THE CONTRACTOR FAILS TO VERIFY AND CONFIRM THE STATED VERSUS ACTUAL SITE CONDITIONS AND THEIR COMPATIBILITY WITH NEW CONSTRUCTION PRIOR TO BEGINNING WORK AND DISCREPANCIES DO IN FACT EXIST, THE CONTRACTOR SHALL BE RESPONSIBLE FOR ANY AND ALL MODIFICATIONS TO CONSTRUCTION WORK AS DIRECTED BY THE ARCHITECT INCLUDING REPLACEMENT OF HARDSCAPE ITEMS, FIXTURES AND SITE IMPROVEMENTS AT NO ADDITIONAL COST TO THE OWNER.

J. SEE LANDSCAPE, ARCHITECTURAL, STRUCTURAL, MECHANICAL AND ELECTRICAL DRAWINGS FOR MORE INFORMATION.



Architectural NEXUS, Inc. 2505 East Parleys Way Salt Lake City, UT 84109 T 801.924.5000

http://www.archnexus.com

Original drawings remain the property of the Architect and as such the Architect retains total ownership and control. The design represented by these drawings is sold to the client for a one time use, unless otherwise agreed upon in writing by the Architect.

© Architectural Nexus, Inc. 2017

SE ШО 0

Date

INDE


**AMOAN** 

# **KEY MAP** RMF-35

#### CONDITIONAL **USE PERMIT**

NEXUS PROJECT #:21021.01 CHECKED BY: DRAWN BY: DATE: 07.19.24

SITE IMPROVEMENTS **PLAN** 

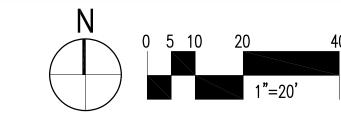



ARCH | NEXUS

Architectural NEXUS, Inc. 2505 East Parleys Way Salt Lake City, UT 84109 T 801.924.5000

http://www.archnexus.com

Original drawings remain the property of the Architect and as such the Architect retains total ownership and control. The design represented by these drawings is sold to the client for a one time use, unless otherwise agreed upon in writing by the Architect.

© Architectural Nexus, Inc. 2017


SAMOAN INDEPENDENT ADVE


CONDITIONAL USE PERMIT

NEXUS PROJECT #:21021.01 CHECKED BY: JG DRAWN BY: JS DATE: 02.27.23


SITE IMPROVEMENT **DETAILS** 

**AS701** 

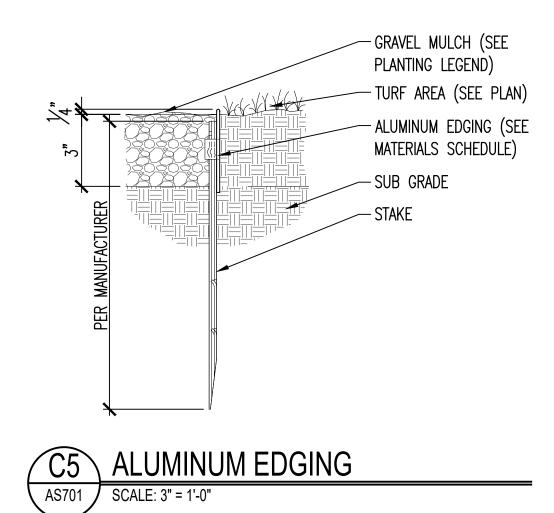

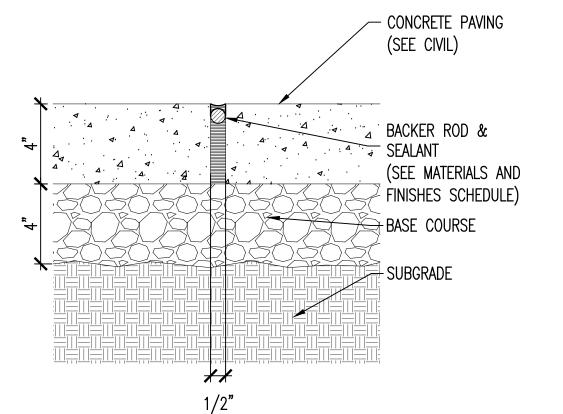



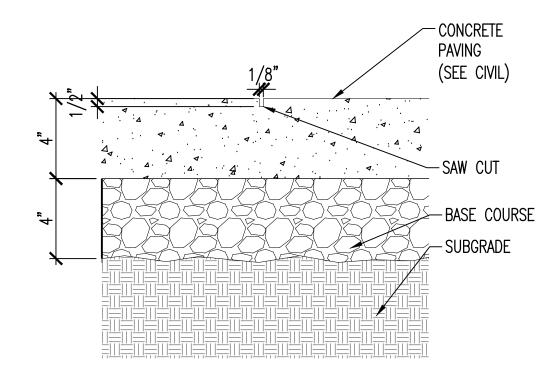




http://www.archnexus.com

Revision

# Date

PHASE 2 -LEVEL 01 **FLOOR PLAN** 

FIXTUREQTYDRINKING FOUNTAIN (DOUBLE BASIN)2LAVATORY10MOP SINK1	LEGEND (M) MEN (R) RESIDENCE (U) UNISEX (W) WOMEN	FIXTURE  (M) LAVATORY	QTY			_		MEN (	50%)		WO	OMEN (50%)		
DRINKING FOUNTAIN (DOUBLE BASIN) 2 LAVATORY 10	(R) RESIDENCE (U) UNISEX	(M) LAVATORY										(******		
LAVATORY 10	` '		3	AREA	OCCUPANCY: DESCRIPTION	PERSONS	MEN	WC / URINAL	MAX URINALS	LAV	WOMEN	WC	LAV	DF
SHOWER 2		(M) URINAL (M) WATER CLOSET (R) LAVATORY	2 2	exhibiti	bly: Auditoriums without permanent seating, art galleries, on halls, museums, lecture halls, libraries, arcades and	323.0	161.48	1.29	0.65	0.81	161.48	2.48	0.81	0.65
SINK, KITCHEN 3 URINAL 2 WATER CLOSET 10		(R) LAVATORY (R) WATER CLOSET (U) LAVATORY (U) WATER CLOSET (W) LAVATORY	2 2 2 2	2,970 SF Busines service	siums bly: Places of worship and other religiuos services ss: Buildings for the transaction of business, professional s, other services involving merchandise, office buildings, light industrial, ambulatory care and similar uses	360.3 19.8	180.15 9.90	1.20 0.40		0.90 0.28	180.15 9.90	2.40 0.40	0.90 0.28	
		(W) WATER CLOSET - DRINKING FOUNTAIN (DOUBLE BASIN) - MOP SINK	4 2 1	609 SF Educat 1,194 SF Reside 249 SF Storage	ional: Educational facilities ntial: Hotels, motels, boarding houses (transient) e: Structures for the storage of goods, warehouses, buses and freight depots, low and moderate hazard	30.4 6.0 0.8	15.22 2.98 0.42	0.30 1.00 0.00		0.30 1.00 0.00	15.22 2.98 0.42	0.30 1.00 0.00	0.30 1.00 0.00	0.01

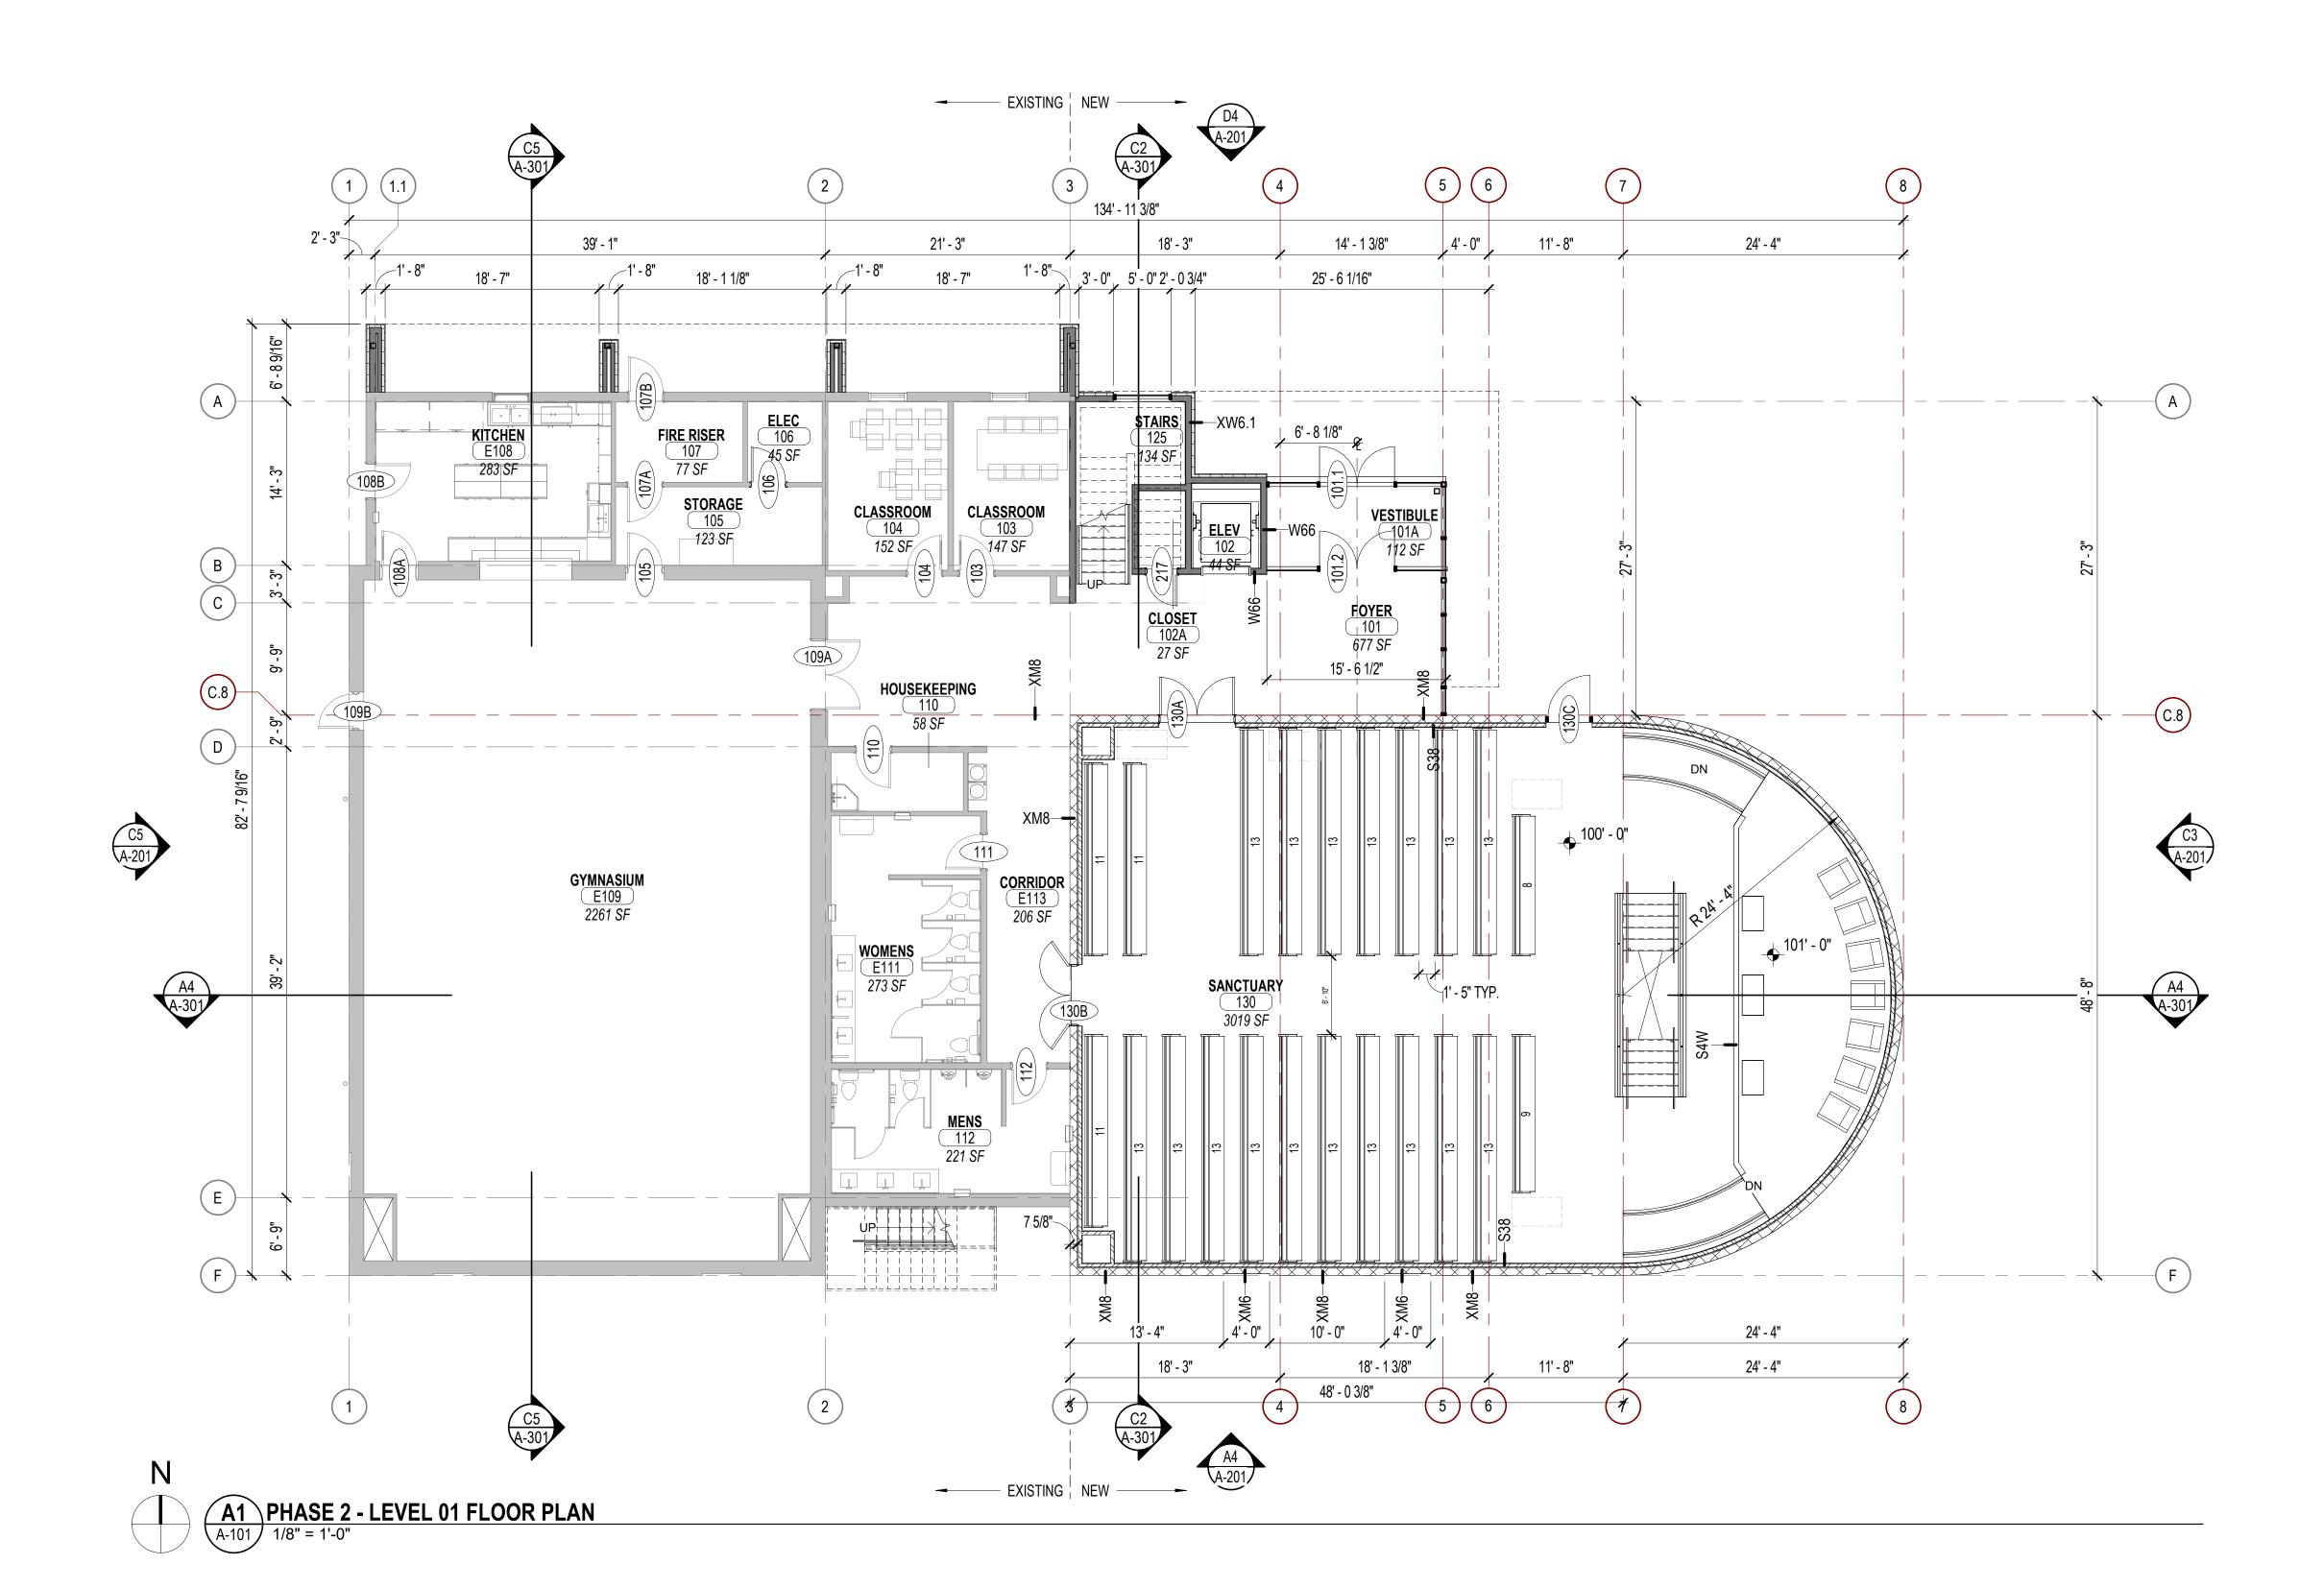

Original drawings remain the property of the Architect and as such the Architect retains total ownership and control. The design represented by these drawings is sold to the client for a one time use, unless otherwise agreed upon in writing by the Architect.

© Architectural Nexus, Inc. 2017

SAMOAN INDEPENDENT SEVENTH-DAY ADVENTIST CHURCH SDAC Utah, Phase 2


# Date Revision

# CONDITIONAL USE PERMITTING

NEXUS PROJECT #21021.01 CHECKED BY: -DRAWN BY: -DATE: 31 JULY 2024

PHASE 2 -LEVEL 02 FLOOR PLAN

A-102

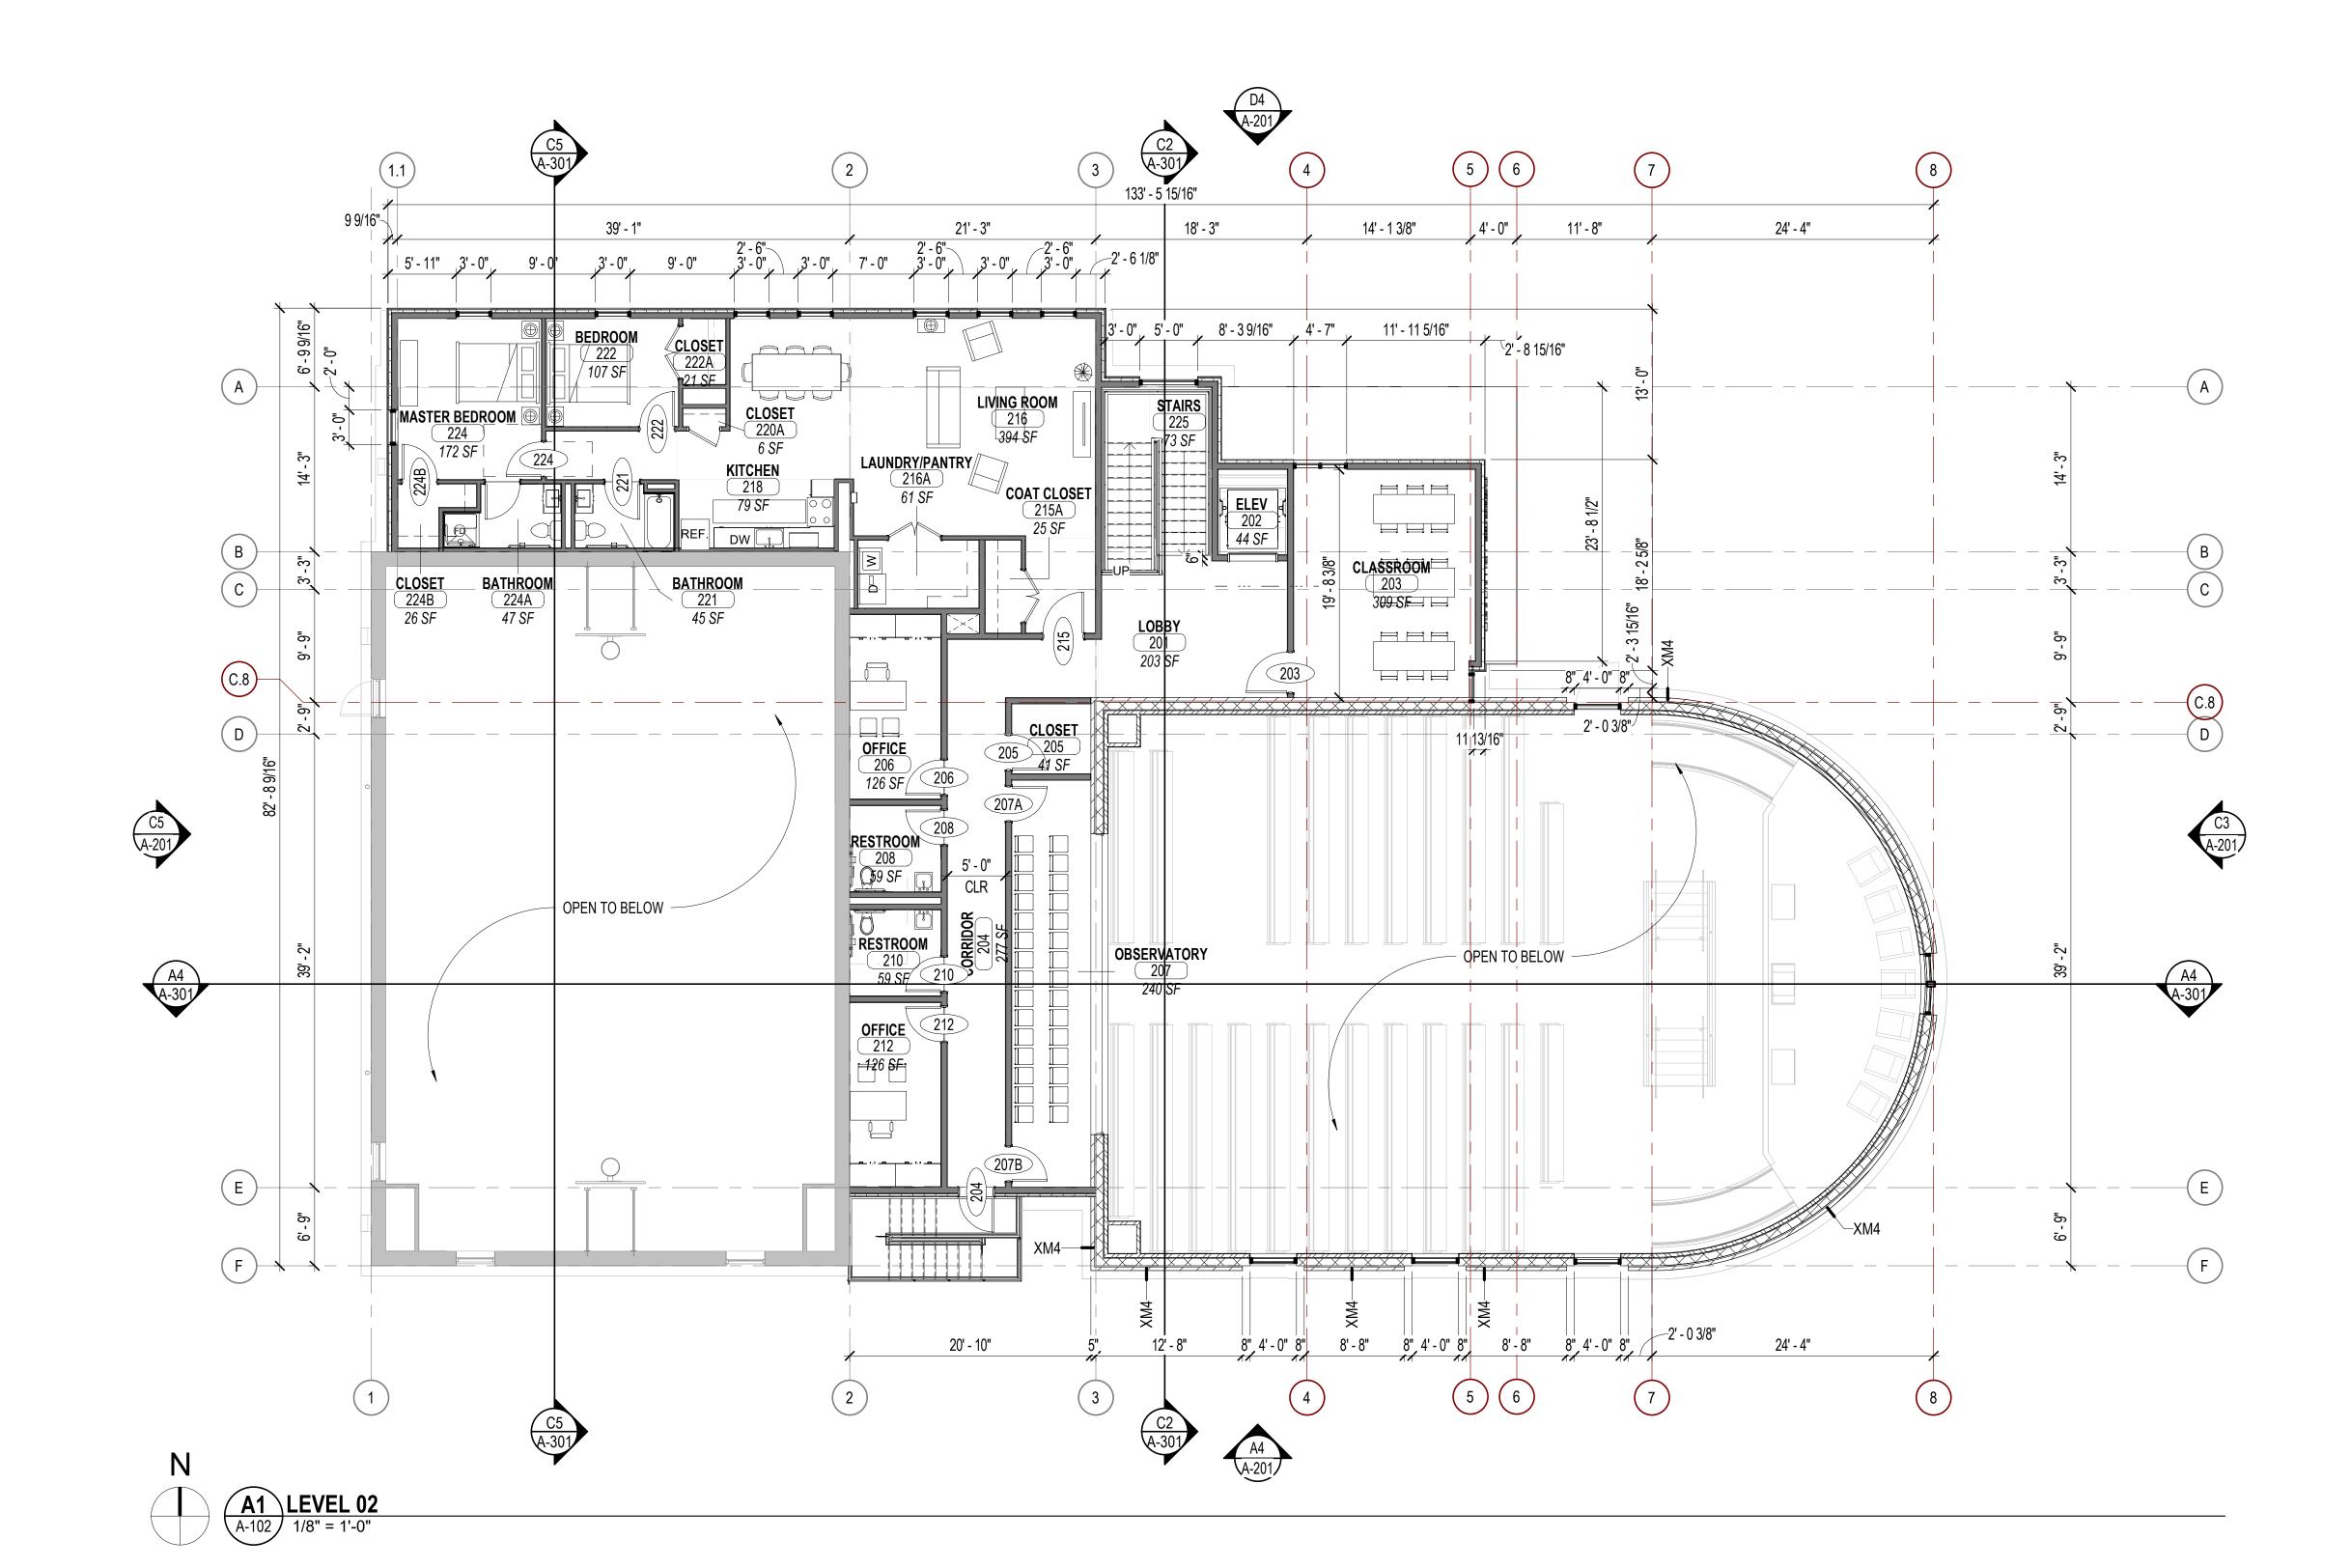

\_

C

12:36 AM

Architectural NEXUS, Inc. 2505 East Parleys Way Salt Lake City, UT 84109 T 801.924.5000 http://www.archnexus.com

Original drawings remain the property of the Architect and as such the Architect retains total ownership and control. The design represented by these drawings is sold to the client for a one time use, unless otherwise agreed upon in writing by the Architect.

© Architectural Nexus, Inc. 2017

#### **KEYNOTE LEGEND**

07:DS3 THRU-WALL SCUPPER WITH PRE-FINISHED CONDUCTOR, HEAD AND DOWNSPOUT. COLOR TO MATCH PAINT COLOR FOR SIDING.

23:CU1 CONDENSING UNIT; SEE MECHANICAL ROOF TOP UNIT; SEE MECHANICAL

10:RH2 ROOF HATCH
11:LR1 ROOF TOP LADDER PAINTED TO MATCH
EXTERIOR SIDING

23:CU1 CONDENSING UNIT: SEE MECHANICAL


SAMOAN INDEPENDENT SEVENTH-DAY
ADVENTIST CHURCH
ADVENTIST CHURCH


Date Revision

# CONDITIONAL USE PERMITTING

NEXUS PROJECT #21021.01 CHECKED BY: -DRAWN BY: -DATE: 31 JULY 2024

PHASE 2 -ROOF PLAN

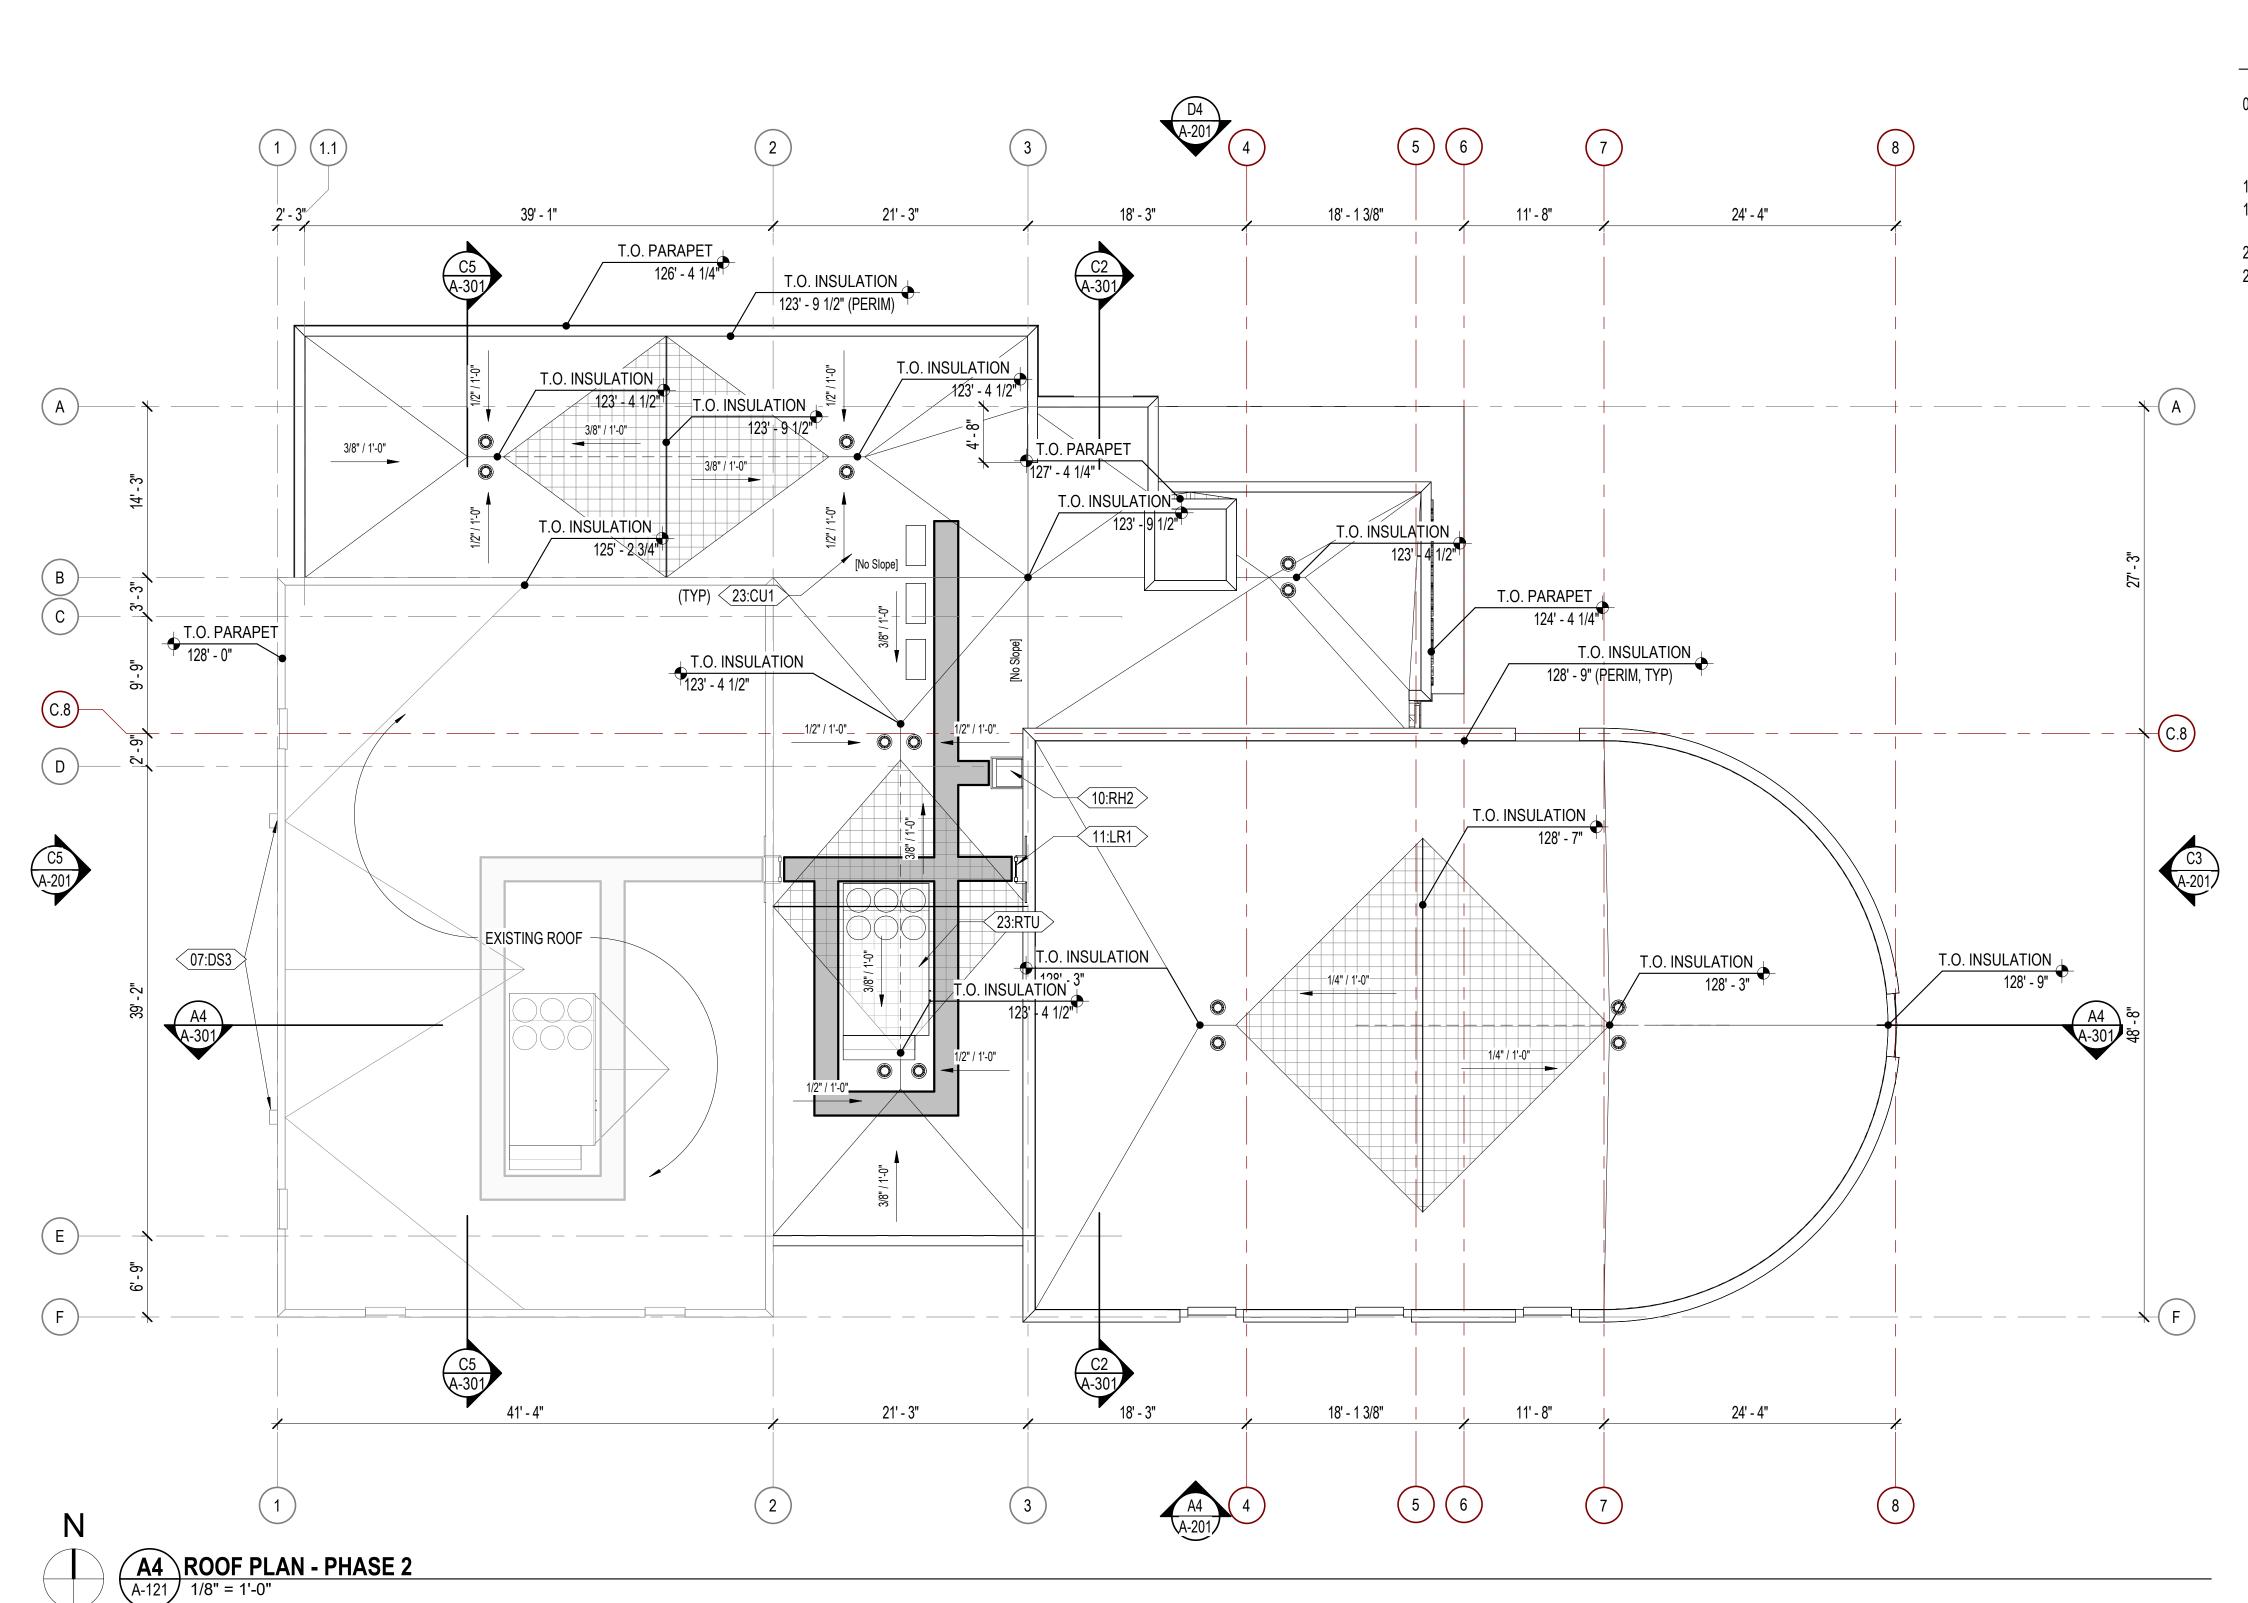

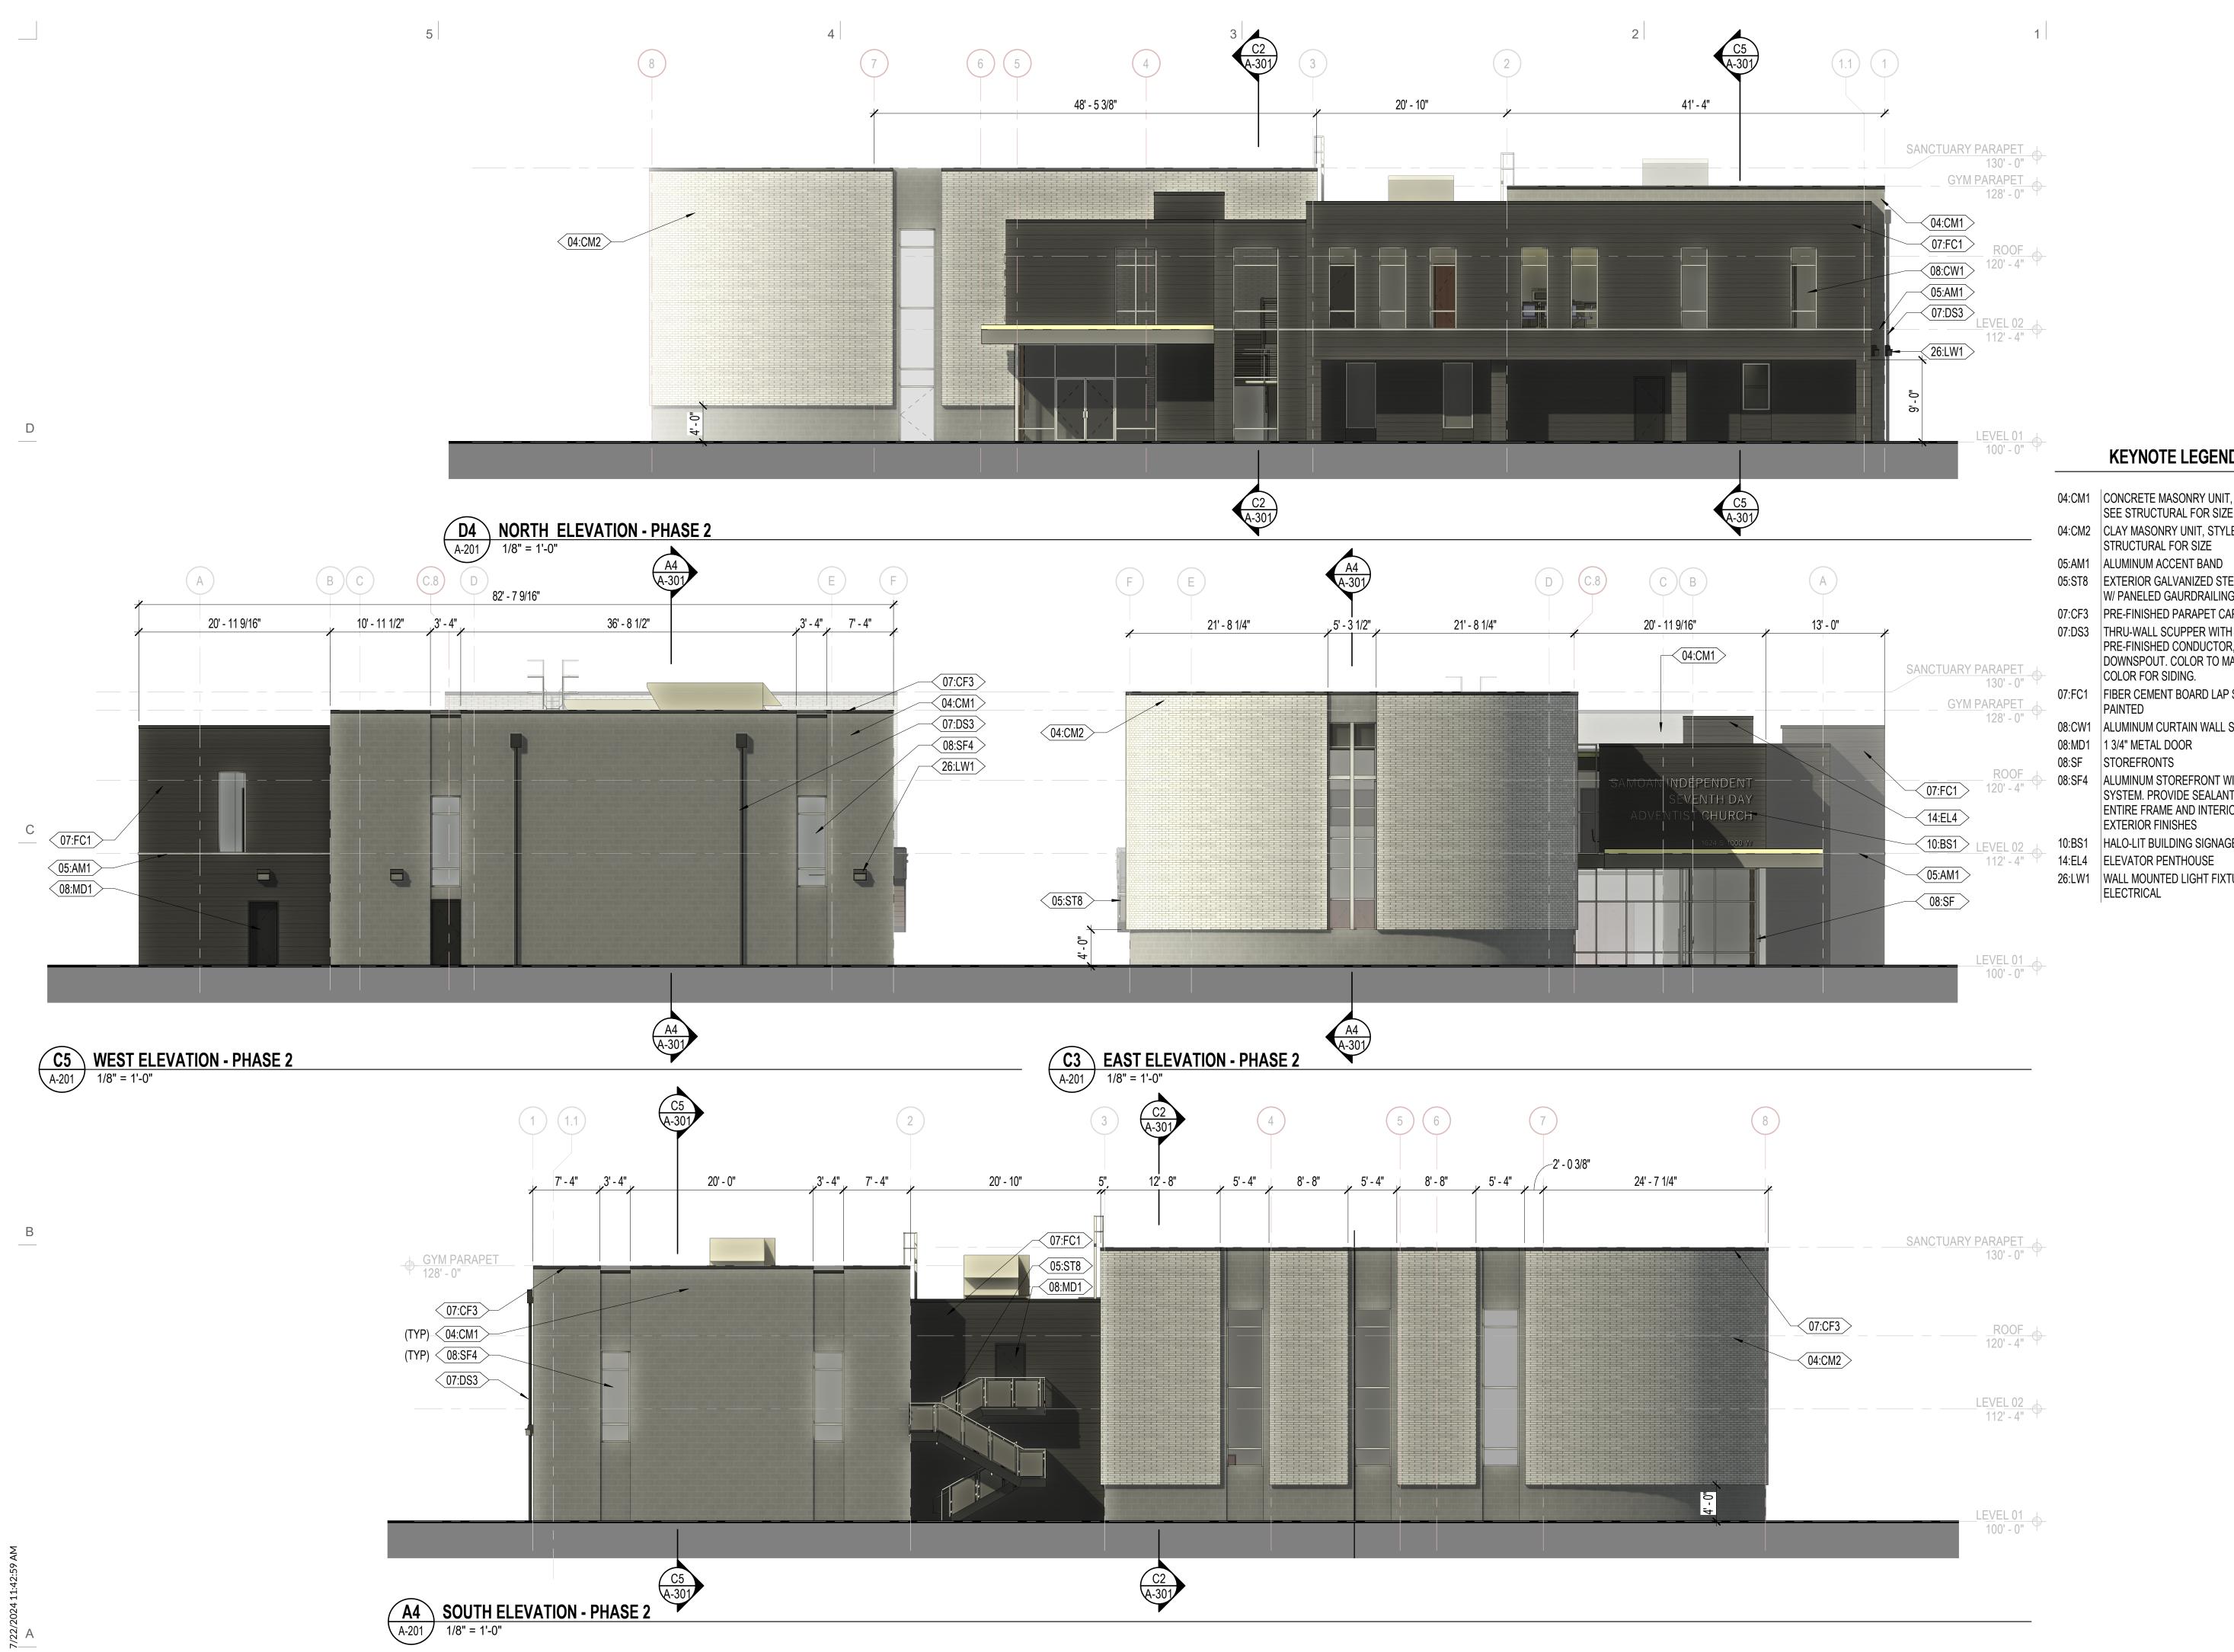



Architectural NEXUS, Inc. 2505 East Parleys Way Salt Lake City, UT 84109

© Architectural Nexus, Inc. 2017

PENDENT SEVE ADVENTIST

SAMOAN INDE

T 801.924.5000 http://www.archnexus.com

Original drawings remain the property of the Architect and as such the Architect retains total ownership and control. The design represented by these drawings is sold to the client for a one time use, unless otherwise agreed upon in writing by the Architect.

#### **KEYNOTE LEGEND**

04:CM1 | CONCRETE MASONRY UNIT, STYLE 1. SEE STRUCTURAL FOR SIZE 04:CM2 CLAY MASONRY UNIT, STYLE 2. SEE STRUCTURAL FOR SIZE 05:AM1 ALUMINUM ACCENT BAND

05:ST8 EXTERIOR GALVANIZED STEEL STAIRS W/ PANELED GAURDRAILING, PAINTED 07:CF3 PRE-FINISHED PARAPET CAP FLASHING

PRE-FINISHED CONDUCTOR, HEAD AND DOWNSPOUT. COLOR TO MATCH PAINT COLOR FOR SIDING. 07:FC1 FIBER CEMENT BOARD LAP SIDING;

PAINTED 08:CW1 | ALUMINUM CURTAIN WALL SYSTEM

08:MD1 | 1 3/4" METAL DOOR 08:SF STOREFRONTS 08:SF4 ALUMINUM STOREFRONT WINDOW

SYSTEM. PROVIDE SEALANT BETWEEN ENTIRE FRAME AND INTERIOR AND **EXTERIOR FINISHES** 10:BS1 HALO-LIT BUILDING SIGNAGE


14:EL4 ELEVATOR PENTHOUSE 26:LW1 WALL MOUNTED LIGHT FIXTURE; SEE ELECTRICAL


> # Date Revision

#### CONDITIONAL **USE PERMITTING**

NEXUS PROJECT #21021.01 CHECKED BY: -DRAWN BY: -DATE: 31 JULY 2024

PHASE 2 -BUILDING **ELEVATIONS** 

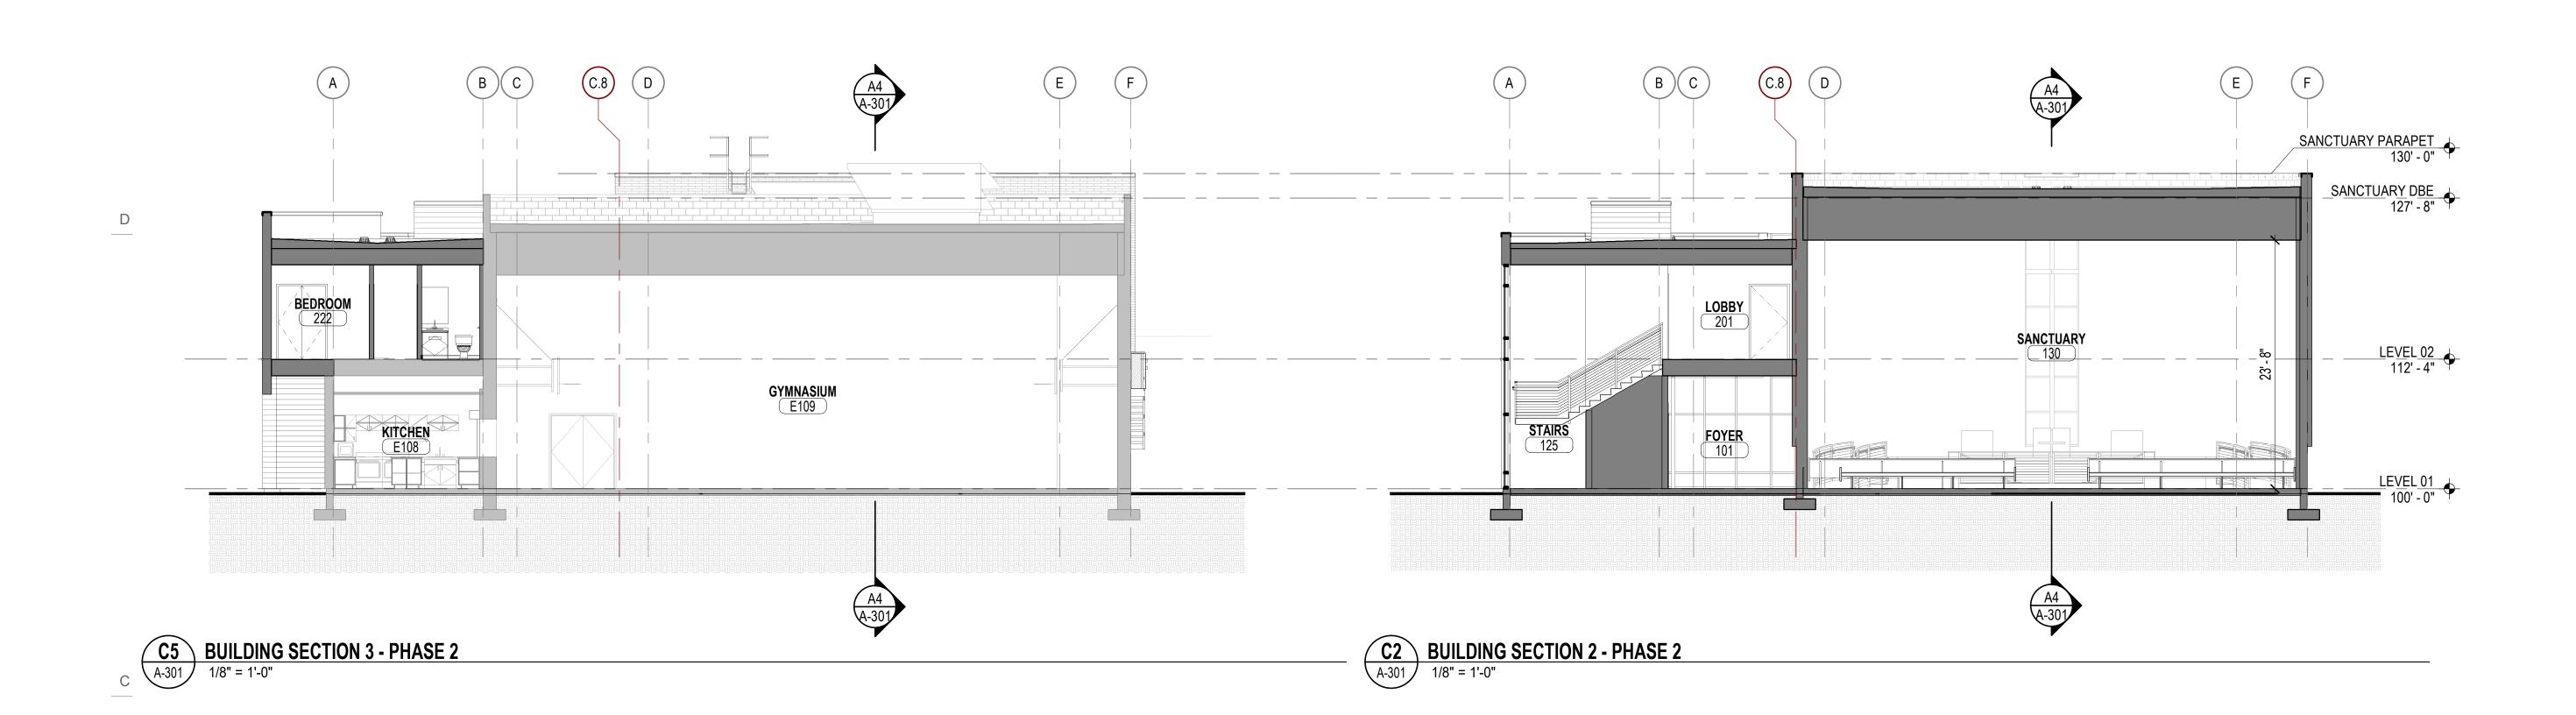

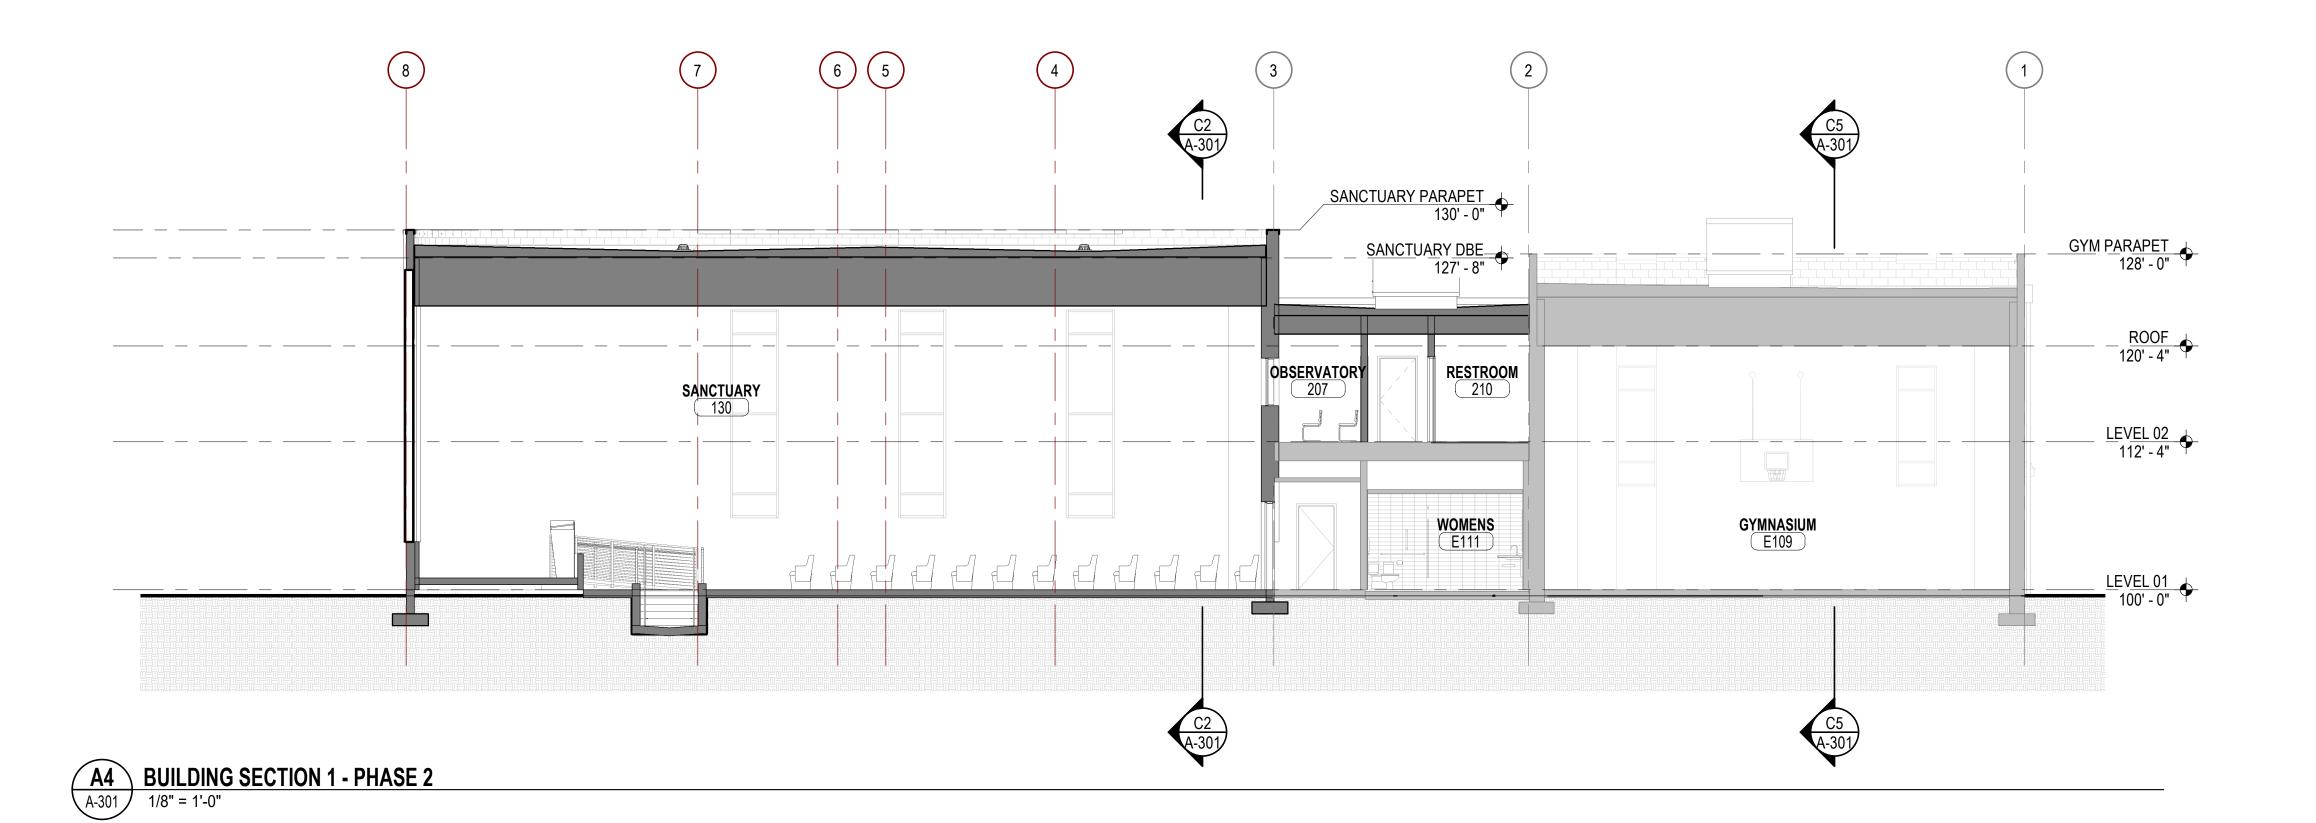



Architectural NEXUS, Inc. 2505 East Parleys Way Salt Lake City, UT 84109 T 801.924.5000 http://www.archnexus.com

Original drawings remain the property of the Architect and as such the Architect retains total ownership and control. The design represented by these drawings is sold to the client for a one time use, unless otherwise agreed upon in writing by the Architect.

© Architectural Nexus, Inc. 2017


SAMOAN INDEPENDENT SEVENTH-DAY ADVENTIST CHURCH

# Date

#### CONDITIONAL **USE PERMITTING**

NEXUS PROJECT #21021.01 CHECKED BY: -DRAWN BY: -DATE: 31 JULY 2024 31 JULY 2024

PHASE 2 -**BUILDING SECTIONS** 

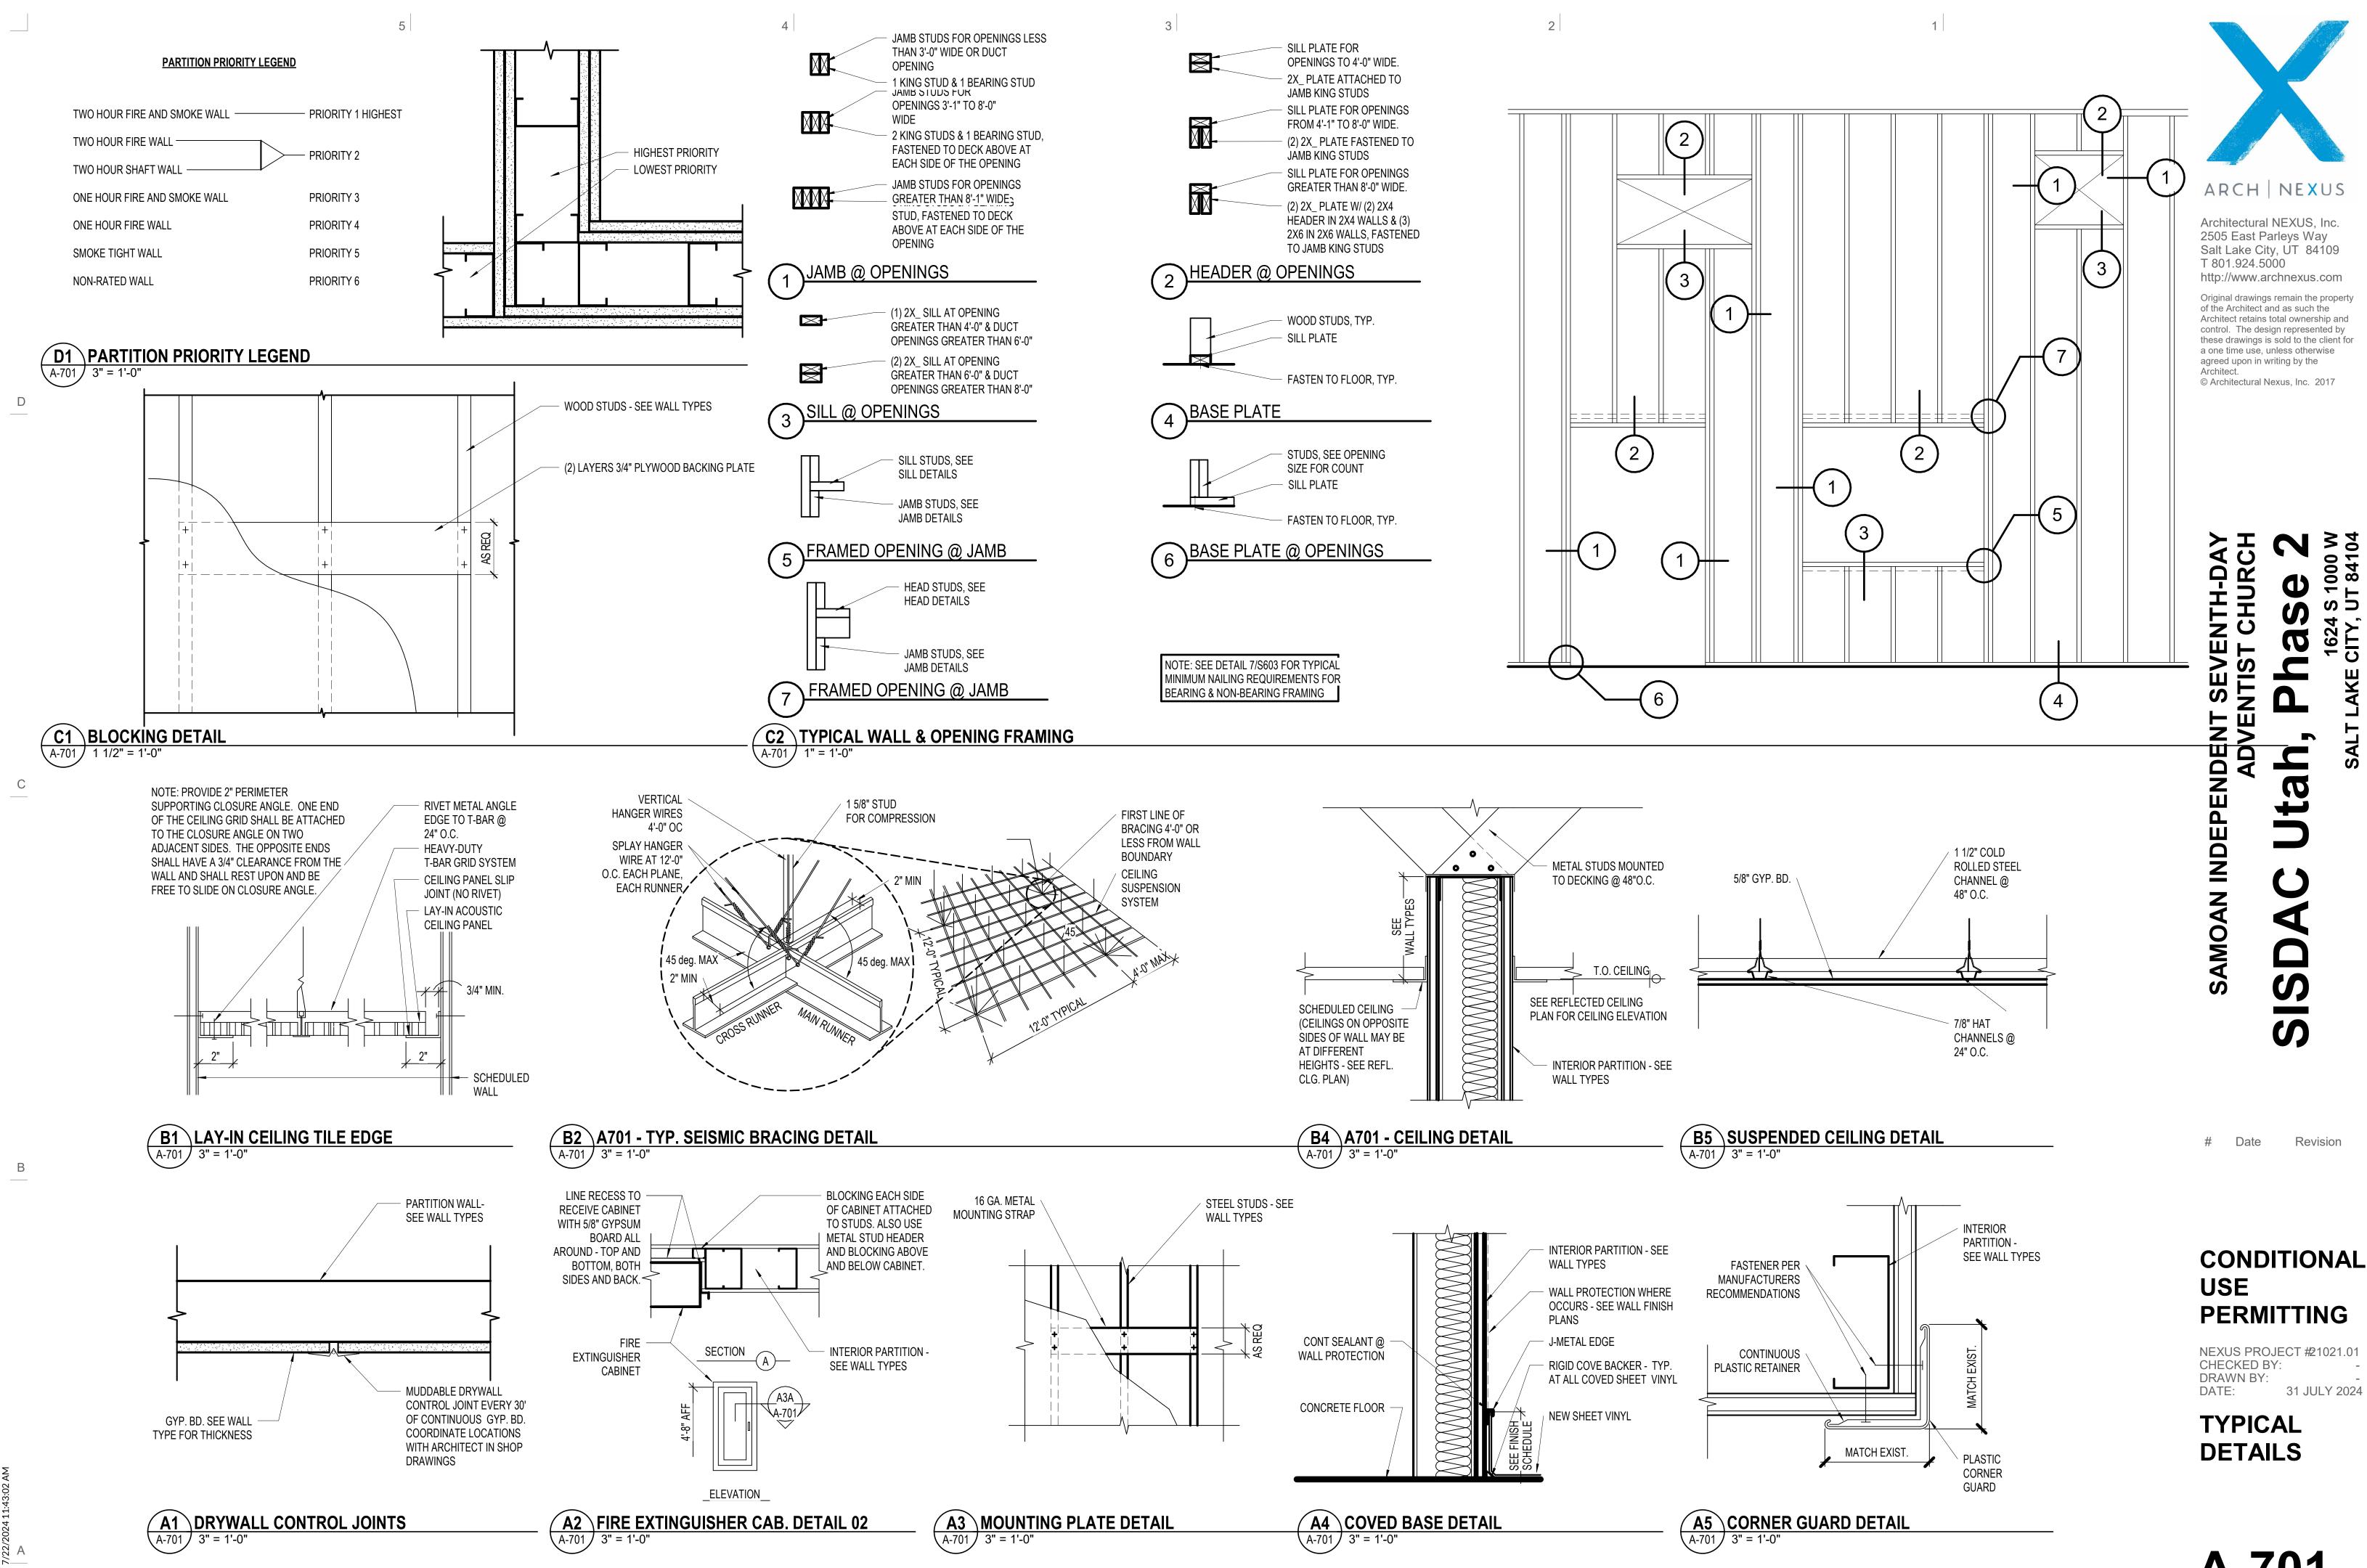

**A-701** 

31 JULY 2024